#### TOWN OF SALISBURY, CONNECTICUT HISTORIC DISTRICT COMMISSION

#### APPLICATION FOR CERTIFICATE OF APPRORIATENESS

Appl. No. 2024	-DICName of prope	erty OLD STONE HOUSE
Ctf. Issued	Ctf . No	Property No 6-25-2024
	Date	00000

Application is herby made for the issuance of a Certificate of Appropriateness under an "Ordinace Establishing Historic Districts within the Town of Salisbury", duly adopted on February 9, 1970 and enacted pursuant to the enabling authority contained in Sections 7-147(a) through 7-147(k) of the General Statutes of Connecticut, for the proposed work described below and as shown on the photographs, plans, or drawings (where applicable or appropriate), accompanying this application:

Address of proposed work <u>264 Taconic Road Salisbury, CT</u>

Owner Arek Feredjian/Elina Tunyan Owner's address 264 Taconic Road Salisbury, CT

Applicant, if not owner\_\_\_\_\_

Agent or contractor\_\_\_\_\_

Address

Proposed work is in connection with: <u>x</u> a dwelling; <u>an accessory building;</u>

\_\_\_\_a commercial building; \_\_\_\_an industrial building; X\_\_\_other (specify)

Nature and description of proposed work (attach extra sheets as necessary);


The work will include a driveway, addition onto the existing dwelling and refurbishment of the existing (historic) windows.

Signature of Applicant <u>Arek Feredjian / Elina Tunyan</u>

Print Name of Applicant Arek Feredjian / Elina Tunyan

Action taken: Historic District Commission	Date
Planning and Zoning Commission	Date
Building Inspector	Date

form updated 9/1/2022

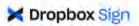

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#### Document History

() Sent	<b>05 / 16 / 2024</b> 19:57:25 UTC-4	Sent for signature to Arek Feredjian (arekbf@gmail.com) from hello@playpop.co IP: 162.125.31.45
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SIGNED	<b>05 / 16 / 2024</b> 19:58:42 UTC-4	Signed by Arek Feredjian (arekbf@gmail.com) IP: 73.142.73.15
COMPLETED	<b>05 / 16 / 2024</b> 19:58:42 UTC-4	The document has been completed.



264 TACONIC RD., SALISBURY, CT 06068

#### JOB DESCRIPTION:

PROPOSED NEW ADDITION CONNECTED WITH BREEZEWAY TO EXISTING ONE-FAMILY HOUSE. ALL RELATED APPLICATIONS WILL BE FILED SEPARATELY. THIS BUILDING WILL BE REVIEWED UNDER 2022 CONNECTICUT STATE BUILDING CODE.

NOT FOR CONSTRUCTION - FOR ILLUSTRATION PURPOSES ONLY

## 264 TACONIC RD.

264 TACONIC RD. SALISBURY, CT 06068

Architect

Daniel Kaplan, RA Bowerbird Architects, PLLC 124 9th St. Suite 250 Brooklyn NY 11215 Tel: 917.447.7855

Owner

AREK FEREDJIAN & ELINA TUNYAN

Code Consultant Code Cunsultant Name and Address

Structural Engineer Structural Engineer Name and Address

## PROGRESS SET 05/14/2024

DOB EXAMINER - SEAL & SIGNATURE

DATE	REVISION

PROJECT

### 264 TACONIC RD. SALISBURY, CT 06068

TITLE

TITLE SHEET

ZONING DISTRICT	000	BLOCK	000
ZONING MAP	000	LOT	000
SEAL & SIGNATUR		DATE	05/14/2024
		JOB NO.:	0141
		SCALE:	
		DRAWING NO .:	
		<b>T00</b> <sup>-</sup>	1.00

## **GENERAL NOTES**

THE FOLLOWING NOTES SHALL APPLY THROUGHOUT DOCUMENTS. EXCEPTIONS ARE SPECIFICALLY NOTED ON EACH DRAWING.

THE GENERAL CONTRACTOR (GC) SHALL FIELD VERIFY ALL DIMENSIONS AND CONDITIONS OF THE SITE AND/OR BUILDING. REPORT ANY DIMENSIONS THAT DEVIATE OR ARE MISSING FROM THE CONTRACT DOCUMENTS TO ARCHITECT TO DETERMINE IF DIFFERENCES WILL AFFECT DESIGN. DO NOT SCALE THESE DRAWINGS.

THE ARCHITECT IS NOT RETAINED TO SUPERVISE THE WORK, GC IS TO REPORT DISCREPANCIES TO ARCHITECT.

THE GC SHALL, UNLESS OTHERWISE PROVIDED IN THE CONTRACT DOCUMENTS, SECURE AND PAY FOR THE REQUIRED CONSTRUCTION PERMIT(S), FEES, LICENSES AND INSPECTIONS NECESSARY FOR THE PROPER EXECUTION OF THE WORK.

COORDINATION OF ALL WORK UNDER THIS CONTRACT SHALL BE MAINTAINED BY GC TO ENSURE THE QUALITY AND TIMELY COMPLETION OF THE WORK/PROJECT. GC 24. THE CONTRACTOR SHALL KEEP THE ARCHITECT INFORMED OF THE PROGRESS SHALL EXAMINE PREMISES BEFORE SUBMITTING A PROPOSAL. NO ALLOWANCE WILL BE OF HIS WORK. NO WORK SHALL BE CLOSED OR COVERED UNTIL IT HAS BEEN DULY MADE FOR LACK OF FULL KNOWLEDGE OF CONDITION OF PREMISES.

THE GC SHALL PERFORM ALL CUTTING AND PATCHING REQUIRED TO COMPLETE THE WORK OF ALL TRADES, OR TO MAKE PARTS FIT TOGETHER WITHOUT COMPROMISING THE QUALITY OF THE WORK.

WOOD FRAMING TO BE HEMLOCK, CONSTRUCTION GRADE, 1450 PSF, OR APPROVED EQUAL. FRAMING TO COMPLY WITH SPECIFICATIONS STRUCTURAL ENGINEER.

OFFICIAL GRADE MARKS MUST BE AFFIXED ON LUMBER BEFORE DELIVERY TO SITE.

METAL FRAMING TO MEET STANDARDS BY THE LOCAL BUILDING CODE, ASTM AND AISI. GALVANIZED STEEL STUDS TO BE 16 GA. @ 16" O.C. WITH DEPTHS AS INDICATED ON PLANS

THE GC SHALL BE RESPONSIBLE FOR ADEQUATELY BRACING AND PROTECTING ALL WORK DURING CONSTRUCTION AGAINST DAMAGE, BREAKAGE, COLLAPSE, DISTORTIONS, AND MIS-ALIGNMENTS ACCORDING TO CODES AND STANDARDS OF GOOD PRACTICE.

10. DRYWALL IN BATHROOM TO BE 5/8" MOISTURE RESISTANT GYPSUM BOARD AS PER 486-39SM. USE CEMENTITIOUS 1/2" BACKER BOARD WHEN TILE SURFACES ARE IN CONTACT WITH WATER, U.O.N.

11. FIRE-RETARD ALL COMBUSTIBLE MATERIAL WITHIN ONE FOOT OF COOKING APPARATUS; MAINTAIN TWO FOOT CLEARANCE ABOVE COOKING APPARATUS.

12. BATHROOMS TO HAVE TILE FLOORS WITH 6" SANITARY BASE MINIMUM. SEE ELEVATIONS FOR HEIGHTS OF TILE ON WALLS.

15. THE GC SHALL NOT INSTALL SUSPENDED OR FURRED CEILINGS IN AREAS WHERE PIPES ARE TO BE CONCEALED (HEATING, PLUMBING) UNTIL THE PIPING HAS BEEN TESTED.

16. THE GC SHALL COORDINATE THE INSTALLATION OF PLUMBING FIXTURES PRIOR TO THE CONSTRUCTION OF PARTITIONS BEHIND SUCH FIXTURES USING SPEC SHEETS AND INSTALLATION INSTRUCTIONS FROM MANUFACTURER.

17. THE GC SHALL EXTEND FLOORING MATERIAL INTO ALL WARDROBES AND CLOSETS. CONSULT ARCHITECT ABOUT AREAS IN QUESTION.

18. ALL ELECTRICAL INDICATIONS ON ARCHITECTURAL DRAWINGS ARE FOR CODE COMPLIANCE BUT ARE GENERALLY PLACED FOR LOCATION PURPOSES ONLY. CONSULT ARCHITECT FOR LOCATION OF FIXTURES, DEVICES, SECURITY ITEMS, ETC. IN QUESTION.

## **DEMOLITION NOTES**

CONTRACTOR SHALL PERFORM ALL DEMOLITION AND REMOVAL INDICATED ON THE DRAWINGS AND AS REQUIRED BY THE WORK, ALL WORK SHALL BE DONE CAREFULLY AND NEATLY, IN A SYSTEMATIC MANNER, OVERSEEN BY GC

ALL EXISTING SURFACES AND EQUIPMENT TO REMAIN SHALL BE FULLY PROTECTED FROM DAMAGE. THE CONTRACTOR SHALL ASSUME FULL RESPONSIBILITY FOR DAMAGE AND SHALL MAKE REPAIRS REQUIRED WITHOUT ADDITIONAL COST TO THE OWNER.

NO DEBRIS SHALL BE ALLOWED TO ACCUMULATE ON THE SITE. DEBRIS SHALL BE REMOVED BY THE CONTRACTOR AS THE JOB PROCEEDS. THE SITE SHALL BE LEFT BROOM CLEAN DURING AND AT THE COMPLETION OF DEMOLITION.

NO STRUCTURAL ELEMENTS SHALL BE REMOVED UNLESS PORTIONS AFFECTED ARE ADEQUATELY SUPPORTED BY EITHER TEMPORARY SHORING OR NEW STRUCTURAL ELEMENTS AS REQUIRE TO PROTECT THE STABILITY AND INTEGRITY OF THE EXISTING STRUCTURE.

ALL ADJOINING PROPERTY AFFECTED BY ANY OPERATIONS OF DEMOLITION SHALL BE PROTECTED PER THE REQUIREMENTS OF BUILDING CODE. 19. THE GC SHALL COORDINATE OPENINGS IN THE FOUNDATION AND EXTERIOR WALLS FOR THE INSTALLATION OF CONDUITS AND BOXES FOR ELECTRICAL EQUIPMENT.

WHERE MANUFACTURES' NAMES AND PRODUCT NUMBERS ARE INDICATED ON 21. THE DRAWINGS, IT SHALL BE CONSTRUED TO MEAN THE ESTABLISHING OF QUALITY AND PERFORMANCE STANDARDS OF SUCH ITEMS. SUBSTITUTIONS OF OTHER PRODUCTS MUST BE SUBMITTED TO THE ARCHITECT FOR APPROVAL BEFORE THEY SHALL BE DEEMED EQUAL.

22. FIRESTOPPING SHALL BE INSTALLED AT ALL PENETRATIONS OF FIRE RATED CONSTRUCTION AS PER SPECIFICATIONS. MATERIAL IS TO BE APPROPRIATE FOR THE ASSEMBLY AND SHALL HAVE AN MEA NUMBER.

23. SIZE OF MASONRY UNITS AND WOOD MEMBERS ON PLANS, BUILDING ELEVATIONS AND SECTIONS ARE SHOWN AS NOMINAL SIZE.

INSPECTED AND APPROVED. SHOULD UNINSPECTED WORK BE COVERED, THE CONTRACTOR, AT HIS OWN EXPENSE, SHALL UNCOVER ALL SUCH WORK SO THAT IT CAN BE PROPERLY INSPECTED, AND AFTER SUCH INSPECTION, HE SHALL PROPERLY REPAIR AND REPLACE ALL SUCH WORK. ALL WORK SHALL BE SUBJECT TO FINAL INSPECTION BY THE ARCHITECT.

25. THE CONTRACTOR SHALL GUARANTEE THE WORK AGAINST DEFECTS IN MATERIALS OF WORKMANSHIP FOR A PERIOD OF ONE YEAR FROM THE DATE OF FINAL PAYMENT OF COMPLETED WORK BY OWNER, AND HE SHALL AT HIS OWN EXPENSE, AND WITHOUT COST TO THE OWNER, CORRECT ANY DEFECTS WHICH MAY DEVELOP DURING SUCH ONE YEAR PERIOD AND CORRECT ANY DAMAGE TO OTHER WORK CAUSED BY SUCH DEFECTS.

26. ALL DIMENSIONS ARE TAKEN FROM FINISH TO FINISH, OTHER THAN ROUGH OPENINGS FOR WINDOWS. DOOR DIMENSIONS ARE SHOWN TO INSIDE OF JAMB

27. DO NOT SCALE DRAWINGS. VERIFY ALL DIMENSIONS IN FIELD. REPORT ANY DIMENSIONS THAT DEVIATE FROM CONTRACT DOCUMENTS TO ARCHITECT.

METHODS, MEANS AND MATERIALS SUBMISSIONS: 28. THE GC SHALL BE RESPONSIBLE FOR SUBMITTING HIS AND HIS SUBCONTRACTOR'S SPECS, LITERATURE, MANUFACTURER'S CUTSHEETS OF EQUIPMENT, SHOP DRAWINGS WHERE APPLICABLE, AND SAMPLES OF MATERIALS THAT ARE SHOWN ON THE DRAWINGS OR OF AN EQUAL SUBSTITUTION IF REQUESTED. HE SHALL FIRST REVIEW THE SUBMISSION FOR COMPLETENESS AND COMPLIANCE BEFORE PASSING IT ON TO THE ARCHITECT FOR THEIR APPROVAL. THIS WOULD ALSO HOLD FOR ADDITIONAL CHANGES TO THE WORK THAT ARE MADE DURING THE PROGRESS OF THE JOB. THE OWNER, ARCHITECT AND GC SHALL DISCUSS THIS PARAGRAPH FOR COMPLIANCE WITH REGARD TO ANY SUBCONTRACTOR HIRED DIRECTLY BY THE OWNER TO DETERMINE PROCEDURES TYPICAL FOR THE PROJECT.

29. FOR ANY ITEMS PURCHASED BY OWNER OR GC, THE GC SHALL OBTAIN AND SUBMIT FOR THE ARCHITECT'S REVIEW AND APPROVAL, ANY SHOP DRAWINGS OR PRODUCT CUTSHEETS, ALONG WITH MANUFACTURER'S NAMES, CATALOG NUMBERS INSTALLATION INSTRUCTIONS, AND WARRANTEES, SPECIFIED IN THE CONTRACT DOCUMENTS, OR AS THE GC REQUESTS. THE G.C. SHALL ALSO RETAIN ALL INVOICES FOR ALL PURCHASES RELATED TO CONSTRUCTION, AND THE GC SHALL BE RESPONSIBLE FOR RECEIVERSHIP AND SAFEKEEPING OF ALL ITEMS THEREAFTER. SUBSTITUTIONS SHALL ALSO FOLLOW THE ABOVE PROCEDURES.

30. THE CONSTRUCTION DOCUMENTS, THAT THE OWNER APPROVES, AND G.C. BUILDS FROM, SHALL SHOW THE DESIGN CONCEPT. THE GC IS RESPONSIBLE FOR MEANS AND METHODS OF CONSTRUCTION. AS SUCH, THE GC SHALL SUBMIT FOR THE ARCHITECT'S REVIEW AND APPROVAL, SHOP DRAWINGS AND PRODUCT CUTSHEETS, WITH MANUFACTURER'S NAMES, CATALOG NUMBERS, INSTALLATION INSTRUCTIONS AND WARRANTEES, EITHER SPECIFIED IN THE CONTRACT DOCUMENTS, OR AS REQUIRED BY THE GC OR OWNER. THE GC SHALL ALSO PRODUCE FOR THE ARCHITECT'S APPROVAL, GRAPHIC DETAILS SHOWING ANYTHING HE PLANS TO CONSTRUCT. WHICH DEVIATES FROM THE SIGNED SET OF CONSTRUCTION DOCUMENTS. SUBSTITUTIONS SHALL ALSO FOLLOW THE ABOVE PROCEDURES.

REMOVE OR RELOCATE ALL WIRING, PLUMBING, AND MECHANICAL EQUIPMENT AFFECTED BY THE REMOVAL OF PARTITIONS. REMOVED PIPES AND/OR LINES SHALL BE CUT TO A POINT OF CONCEALMENT BEHIND OR BELOW FINISH SURFACES, AND SHALL BE PROPERLY CAPPED OR PLUGGED. GC TO ASK OWNER IF ANY ITEMS ARE TO BE SAVED AND SAFELY STORED.

THE CONTRACTOR SHALL PROVIDE, ERECT AND MAINTAIN ALL TEMPORARY BARRIERS AND GUARDS, AND ALL TEMPORARY SHORING AND BRACING AS REQUIRED BY DEPARTMENT OF BUILDING RULES AND REGULATIONS.

THE CONTRACTOR SHALL PROVIDE ADEQUATE WEATHER PROTECTION FOR THE BUILDING AND ITS CONTENTS DURING THE COURSE OF THE WORK. ALL OPENINGS IN ANY WALL OR ROOF SHALL BE PROTECTED FROM ALL FORMS OF WEATHER OR WATER PENETRATION. GC TO SUPPLY HEAT IN COLD WEATHER IF PROJECT HAS PROGRESSED ENOUGH TO REQUIRE IT.

10. THE CONTRACTOR SHALL FILE ALL NECESSARY CERTIFICATES OF INSURANCE WITH THE DEPARTMENT OF BUILDINGS, PAY ALL FEES, OBTAIN ALL PERMITS AND PROVIDE ANY AND ALL BONDS REQUIRED BY ANY CITY AGENCY IN ORDER TO DO THE WORK HEREIN DESCRIBED.

11. GC TO ASK OWNER IF ANY ITEMS ARE TO BE SAVED AND SAFELY STORED.

## BUILDING DEPARTMENT NOTES

GENERAL CONSTRUCTION TO COMPLY WITH STATE OF CT BUILDING CODE.

WORK SHALL BE EXECUTED IN FULL COMPLIANCE WITH THE APPLICABLE PROVISIONS OF ALL LAWS, BY-LAWS, STATUTES, ORDINANCES, CODES, RULES, REGULATIONS AND LAWFUL ORDERS OF PUBLIC AUTHORITIES BEARING ON THE PERFORMANCE AND EXECUTION OF THE WORK. THE CONTRACTOR SHALL PROMPTLY NOTIFY THE ARCHITECT OF ANY PORTIONS OF THE WORK, IN THE CONTRACT DOCUMENTS THAT ARE AT VARIANCE WITH THE ABOVE.

ALL MATERIALS, ASSEMBLIES, FORMS METHODS OF CONSTRUCTION AND SERVICE EQUIPMENT SHALL MEET THE FOLLOWING REQUIREMENTS: THEY SHALL HAVE BEEN ACCEPTABLE PRIOR TO THE EFFECTIVE DATE OF THE CODE.

- THEY SHALL HAVE BEEN ACCEPTED FOR THE USE UNDER THE RESCRIBED TEST METHODS BY THE COMMISSIONER (OR) APPROVED BY THE OFFICE OF TECHNICAL CERTIFICATION AND RESEARCH (OTCR)ARCHITECT FOR LOCATION OF FIXTURES, DEVICES, SECURITY ITEMS, ETC. IN QUESTION.
- MATERIALS OR ASSEMBLIES REQUIRED TO HAVE A FIRE RESISTANCE RATING SHALL COMPLY WITH ONE OF THE FOLLOWING:

THEY SHALL CONFORM WITH A.I.S.G. "FIRE RESISTANCE RATING", DATED 1985 (OR)

THEY SHALL HAVE BEEN TESTED IN ACCORDANCE WITH ASTM E119, 4.b. STANDARD METHODS OF FIRE TESTS OF BUILDING CONSTRUCTION AND MATERIALS AND ACCEPTED BY THE COMMISSIONER (OR) THEY SHALL HAVE BEEN ACCEPTABLE PRIOR TO THE EFFECTIVE DATE OF

THE CODE. 4.d. APPROVED BY OTCR

ALL MASONRY UNITS SHALL CONFORM TO THE BUILDING CODE. 5.

THESE DRAWINGS HAVE BEEN PREPARED BY OR AT THE DIRECTION OF THE UNDERSIGNED AND TO THE BEST OF THE UNDERSIGNED'S KNOWLEDGE, INFORMATION AND BELIEF MEET THE REQUIREMENTS OF THE BLDG. CODE.

- ALL WORK SHALL COMPLY WITH ANSI 117.1 7.
- ALL NEW WORK SHALL COMPLY WITH INTERNATIONAL ENERGY CODE. 8.

ALL NEW INTERIOR FINISHES SHALL BE CONSTRUCTED OF MATERIALS MEETING CODE REQUIREMENT FOR FLAME SPREAD RATINGS.


ALL MATERIALS AND CONSTRUCTION SHALL CONFORM TO THE TOWN BUILDING AND SANITARY CODES. THE GC IS TO BE RESPONSIBLE FOR ANY VIOLATIONS OF THE SAME AND SHALL MAKE ALL WORK ACCEPTABLE TO THE BUILDING DEPARTMENT.

		DRAWI	NG LIST
31. RESPONSIBILITIES FOR MEANS AND METHODS:		Sheet Number	She
THE ARCHITECT SHALL MAKE PROJECT VISITS AS APPROPRIATE TO JOB PR GENERALLY DETERMINE THAT THE WORK IS IN ACCORDANCE WITH THE INT		T001.00	TITLE SHEET
CONSTRUCTION DOCUMENTS AND RELATED DOCUMENTS THAT MAKE UP T CONTRACTOR'S AGREEMENT WITH THE OWNER. THE ARCHITECT SHALL NO		G001.00	GENERAL, DOB & DEMOLITION NOTES
WAY, DIRECT THE CONSTRUCTION MEANS, METHODS, PROCEDURES, SCHE	EDULING OR	G004.00	SURVEY
SAFETY PROGRAM, NOR SHALL THE ARCHITECT BE RESPONSIBLE FOR ANY OR JOB CONDUCT BY ANYONE UNDER CONTRACT TO THE GENERAL CONTR	RACTOR HIS	Z100.00	ZONING ANALYSIS
AGENTS OR EMPLOYEES INCLUDING THOSE OF HIS SUBCONTRACTORS.		EN001.00	ENERGY CODE REQUIREMENTS
32. GC RESPONSIBLE TO THE OWNER FOR COORDINATING INSTRUCTIO	ONS ON	DM101.00	DEMO PLANS
RUNNING THE SYSTEMS THAT ARE INSTALLED (AS THE OWNER MUST TAKE		A100.00	SITE PLAN
BUILDING AFTER CONSTRUCTION IS COMPLETED.) UPON PROJECT COMPLE GC SHALL SCHEDULE SEPARATE MEETINGS BETWEEN THE OWNER AND EA		A101.00	FLOOR PLANS - FIRST FLOOR
MECHANICAL AND ELECTRICAL CONTRACTORS (HVA/CP+E) INCLUDING THE FULLY EXPLAIN THE RUNNING OF THEIR RESPECTIVE INSTALLATION		A102.00	FLOOR- AND ROOFPLANS
HEATING, PLUMBING, AIR-CONDITIONING, ELECTRICAL, MEDIA, SECURITY,	NS (IE,	A103.00	FLOOR- AND ROOFPLANS Copy 1
COMMUNICATIONS, ETC.) • AT THOSE SEPARATE MEETINGS WITH EACH OF THE GC'S SUBCONT	TRACTORS	A201.00	<b>BUILDING ELEVATIONS - FRONT &amp; REAR</b>
TRANSMIT TO THE OWNER, ALL MANUFACTURER'S PRODUCT CUTS, INSTRU	JCTION	A202.00	BUILDING ELEVATIONS - SIDES
MANUALS, MANUFACTURER'S USE AND CARE GUIDELINES AND WARRANTIE PRODUCTS AND EQUIPMENT THE GC AND THE SUBCONTRACTORS HAVE IN		A203.00	BUILDING ELEVATIONS - SIDES
THEREFORE THE GC MUST INFORM ALL PARTIES UNDER ITS CONTRACT FO	<u>PR</u>	A301.00	BUILDING SECTIONS
CONSTRUCTION, TO COLLECT AND SAVE THIS INFORMATION AT THE START CONSTRUCTION. THE GC SHALL DISCUSS WITH THE OWNER, HOW TO COOF		A501.00	CONSTRUCTION DETAILS
OTHER CONTRACTOR'S DIRECTLY HIRED BY THE OWNER AND WHO SHALL		A601.00	WINDOW- AND DOOR SCHEDULES
COLLECT THE DATA INDICATED ABOVE. • THE GC SHALL BE RESPONSIBLE TO HAVE		E101.00	RCP AND ELECTRICAL PLANS
a. HIS PLUMBER TAG ALL SHUT OFF VALVES b. ANY CELLAR VALVES IN THE HEATING SYSTEM NEEDING TAGGING		M101.00	MECHANICAL PLANS
c. HAVE THE ELECTRICIAN IDENTIFY, BY MECHANICAL PRINT, ALL CIRC			
<ul> <li>ELECTRICAL PANELS AND SUB-PANELS. (HAND PRINTING IS NOT PEI</li> <li>d. TAG ANY VALVES FOR THE AIR-CONDITIONING SYSTEM</li> </ul>	RMITTED)		
e. TAG ANY OUTLETS OR JACKS INSTALLED BY ANY OTHER TRADE			
<ul> <li>f. TAG ANY CABLES GOING INTO ANY CELLAR BOARD (IE SECURITY, M COMMUNICATIONS, ETC.)</li> </ul>	IEDIA,		
36. THE GC SHALL SUBMIT TO THE OWNER AND ARCHITECT A CALENDAR W SCHEDULE PRIOR TO THE START OF CONSTRUCTION. THE WORK SCHEDUL			
SHOW THE PHASING IN OF ALL TRADES FROM THE DATE OF THE START OF			
CONSTRUCTION TO THE DATE OF SUBSTANTIAL COMPLETION. IT SHALL BE PERIODICALLY BUT NOT LESS THAN MONTHLY, UNLESS OTHERWISE AGREE			
MUTUAL CONSENT OF THE PARTIES UNDER CONTRACT. THIS SCHEDULE SH	HALL		
INCLUDE MAJOR MATERIAL DELIVERIES AND GOVERNMENTAL INSPECTIONS COMMENCEMENT, SUBSTANTIAL COMPLETION.	S, DATE OF		
<ol> <li>GC SHALL ENSURE ELECTRICIAN INSTALLS RECEPTACLES, PER COI ROOMS WHERE WORK OCCURS.</li> </ol>	DE, IN ALL		
38. MECHANICAL VENTILATION NOTES:			
INTERIOR BATHROOMS TO HAVE FOUR AIR CHANGES PER HOUR. DUCTWOF	RK TO BE 24		
GA. STEEL.			
39. SMOKE/CARBON DIOXIDE DETECTORS:			
A. DWELLING SHALL BE EQUIPPED WITH APPROVED TYPE SMOKE DET DEVICE RECEIVING PRIMARY POWER FROM BUILDING WIRING AND N			
SWITCHES IN THE CIRCUIT OTHER THAN THE OVER CURRENT DEVIC			
<ul> <li>PROTECTING THE BRANCH CIRCUIT.</li> <li>B. SUCH SMOKE DETECTORS MUST BE EITHER IONIZATION CHAMBER <sup>-</sup></li> </ul>	TYPE OR		
PHOTOELECTRIC.			
C. SMOKE DETECTORS SHALL BE INSTALLED WITHIN 15 FEET OF THE E ANY SLEEPING ROOM. THE DEVICE MUST BE WALL OR CEILING MOU		SCODE	OF WORK
INDICATED ON THE DRAWINGS. D. ALL CARBON DIOXIDE DETECTORS MUST BE INSTALLED WITHIN 15 F	NDICATED ON THE DRAWINGS.	SCOFE	
D. ALL CARBON DIOXIDE DETECTORS MUST BE INSTALLED WITHIN 15 F ENTRANCE TO ANY SLEEPING ROOM.		PROPOSED NEW ADDITION CONNECTED WITH BREEZEWAY TO EXIS	
		ALL RELATED APF CODE.	PLICATIONS WILL BE FILED SEPARATELY. THIS BUILDING WI
		ADDK	EVIATIONS


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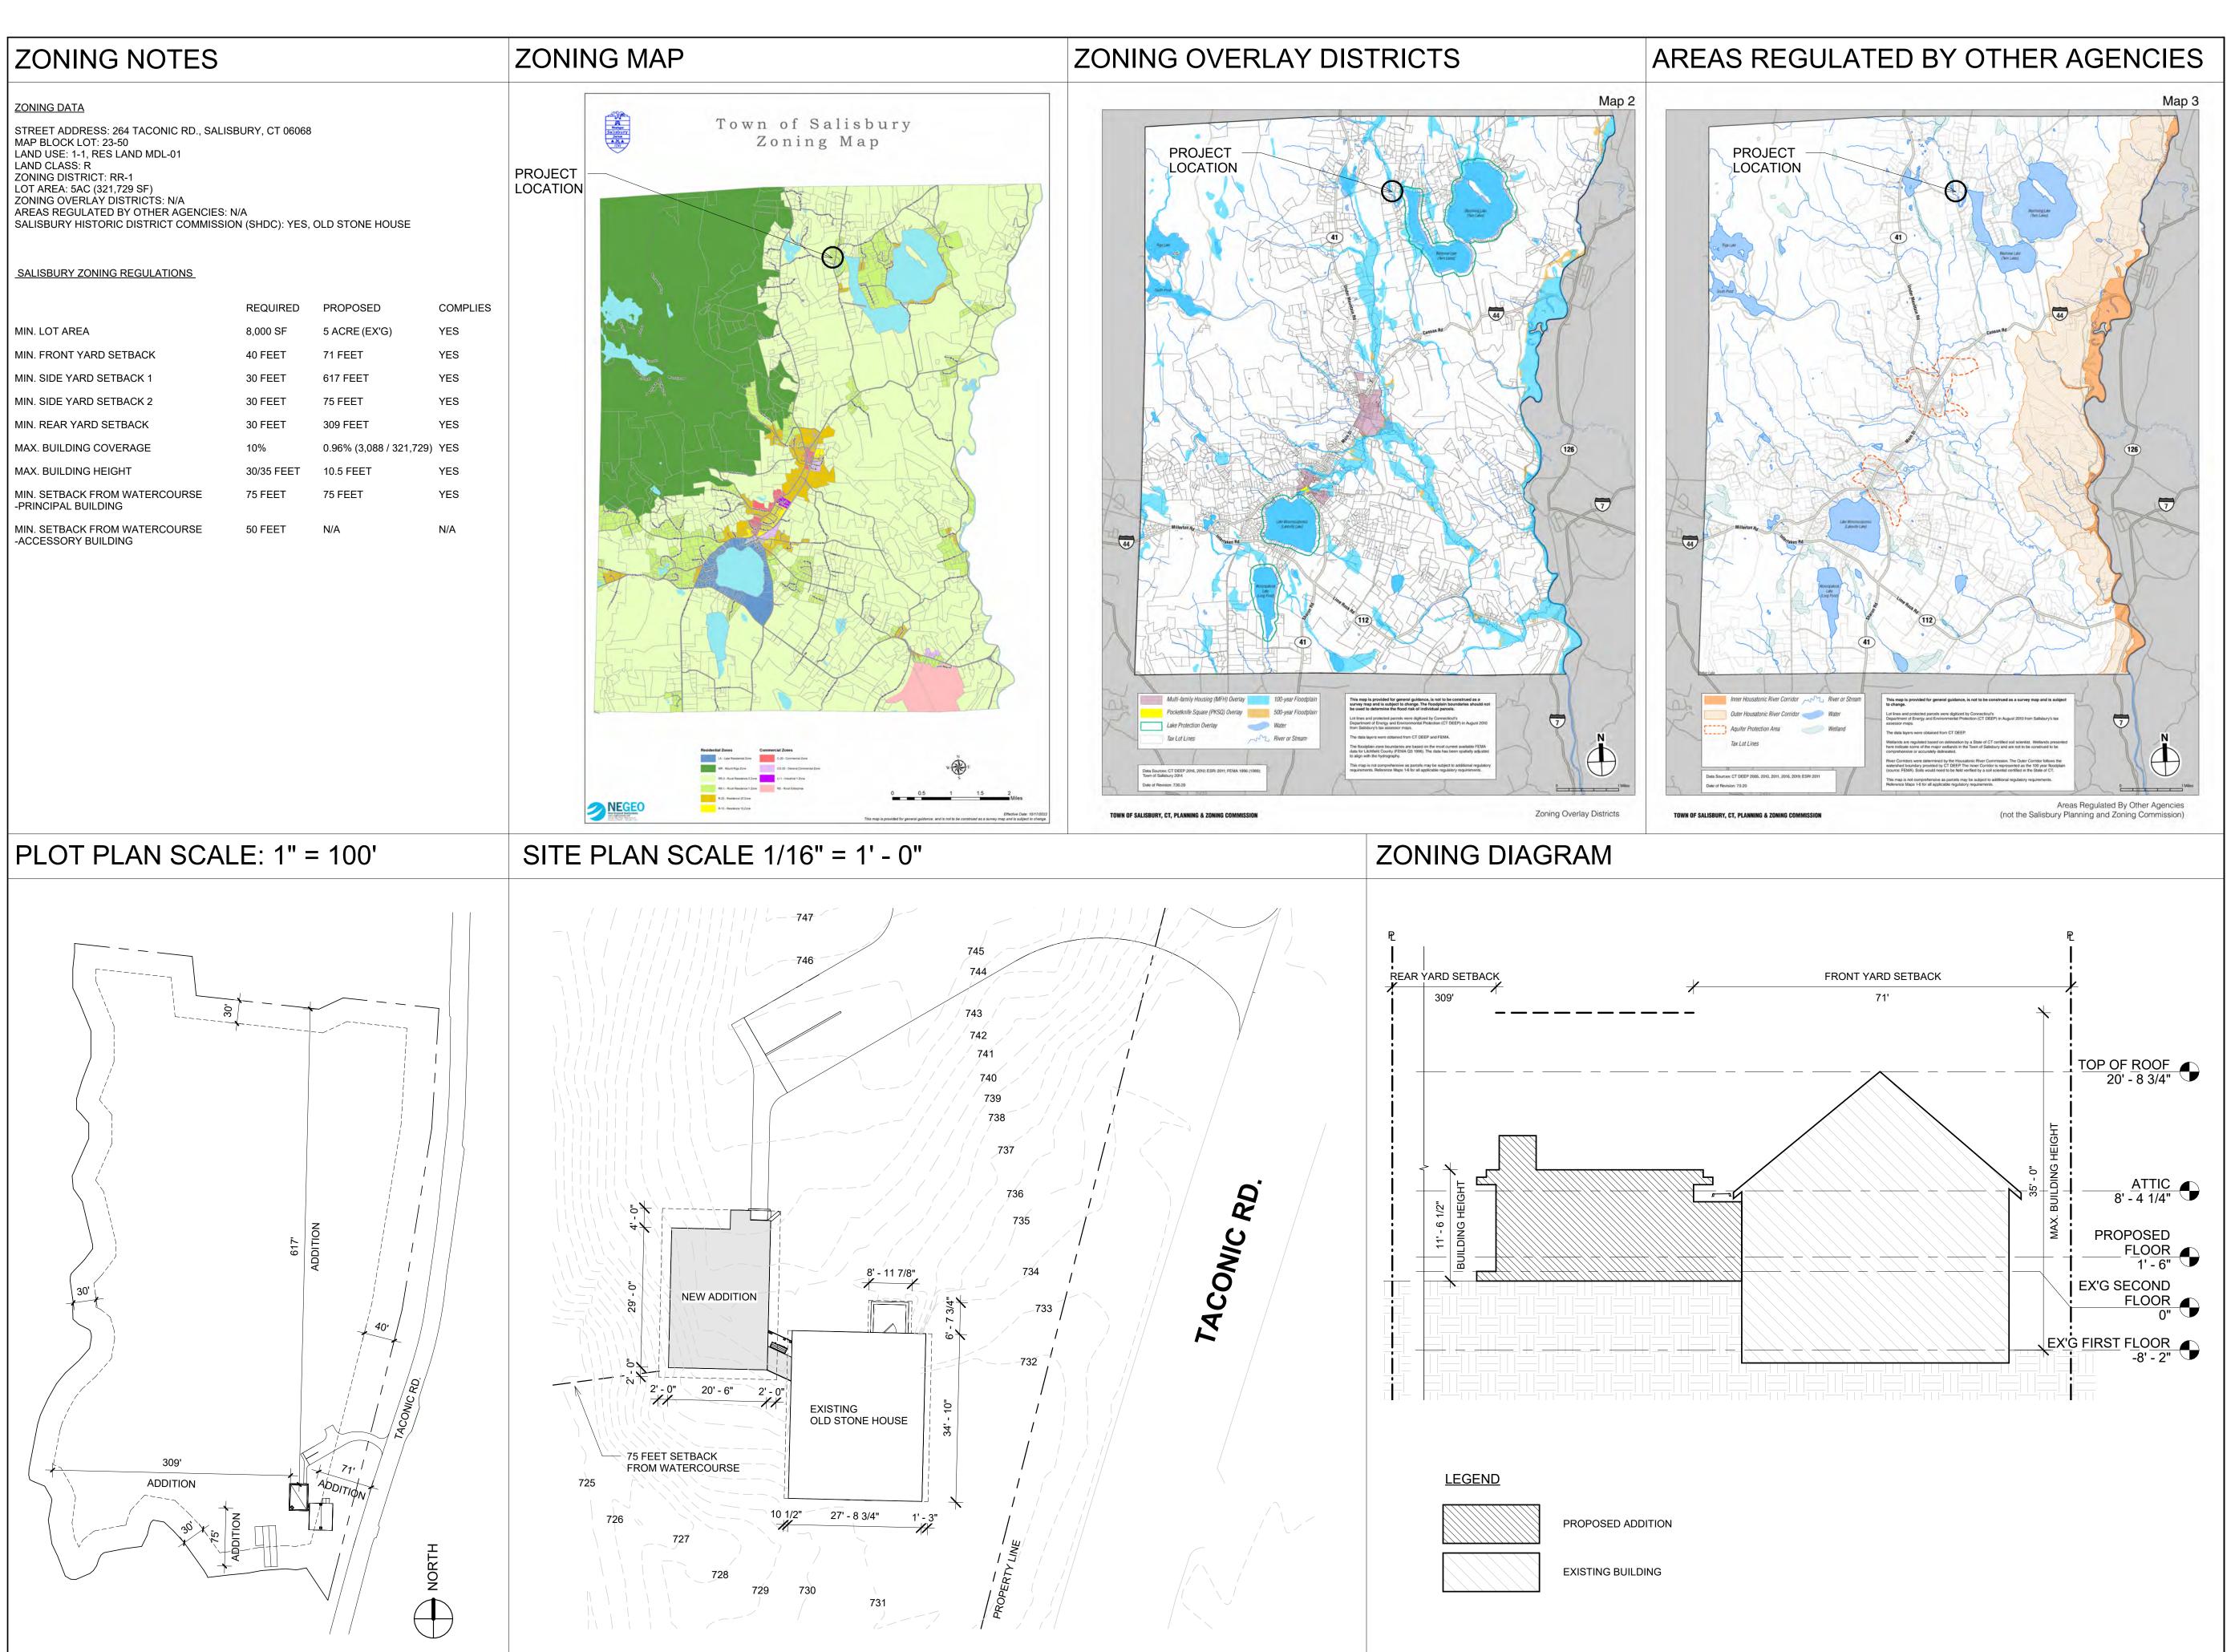
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	ADJ.	- ADJACENT	GA.	- GAUGE
	A.F.F.	- ABOVE FINISHED	GALV.	- GALVANIZED
	FLOOR		G.C.	- GENERAL CO
	APP'D	- APPROVED	GLS.	- GLASS
	&	- AND	G.V.	- GAS VALVE
	<u>@</u>	- AT		- GYPSUM BOA
	B		H	
	B.C.	- BY CONTRACTOR	HGT,	- HEIGHT
	BLDG.	- BUILDING	HR.	- HOUR
	B.O.	- BY OWNER	1	noon
	С. С.	- DI OWNER	' INSUL.	- INSULATION
	CL	- CENTER LINE	L	
	CL.	- CLOSET	LAV.	- LAVATORY
	CLG.	- CEILING	LGT.	- LIGHT
	CONT.	- CONTINUOUS	M	
	CONC.	- CONCRETE	MANF.	- MANUFACTUF
	CU/FT	- CUBIC FEET	MANE. MAT.	- MANOFACTOR
	D	- DEPARTMENT	MAT. MAX.	- MATERIAL
	-		MAA. MECH.	-
	DET.			- MECHANICAL
	DIM.	- DIMENSION	MIN.	- MINIMUM
	DN.	- DOWN	MTL.	- METAL
	DR.	- DOOR	N	
	DWG.	- DRAWING	N.I.C.	- NOT IN CONTI
	E		NO.	- NUMBER
	EL./ ELEV.	- ELEVATION	NOM.	- NOMINAL
	ELEC.		N.T.S.	- NOT TO SCAL
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	ENT.	- ENTRANCE	O.C.	- ON CENTER
	EQ.	- EQUAL	OP'G.	- OPENING
	EQUIP.	- EQUIPMENT	Р	
	EXIST.	- EXISTING	PART.	- PARTITION
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-				
	DRAW	VING CONV	FNTIO	NS
1				



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neet Name		-
		264 TACONIC RD. SALISBURY, CT 06068 Architect
		Daniel Kaplan, RA Bowerbird Architects, PLLC 124 9th St. Suite 250 Brooklyn NY 11215 Tel: 917.447.7855
		Owner AREK FEREDJIAN & ELINA TUNYAN
		Code Consultant Code Cunsultant Name and Address
		Structural Engineer Structural Engineer Name and Address
		PROGRESS SET 05/14/2024
		DOB EXAMINER - SEAL & SIGNATURE
NE-FAMILY HO VILL BE REVIE NTRACTOR ARD RER RACT E	R r RADIUS RAD RADIATOR RCP REFLECTED CEILING PLAN REMV REMOVE REQD REQUIRED RM ROOM S SECT SECTION SHELV'G - SHELVING SHT SHEET SIM SIMILAR SPEC SPECIFICATION SQ. FT./S.F SQUARE FEET S.S./ST. STEEL. STAINLESS STEEL STD STANDARD STL STEEL STOR STORAGE STRUCT STRUCTURAL SQ./YD - SQUARE YARD T TBD - TO BE DETERMINED TEL TELEPHONE THK THICK/THICKNESS TOT OTAL TYP TYPICAL U U.O.N UNLESS OTHERWISE NOTED V V.I.F VERIFY IN FIELD W WAINS WAINSCOT W.I.C WALK IN CLOSET	DATE       REVISION         PROJECT       264 TACONIC RD.         SALISBURY, CT 06068       SALISBURY, CT 06068         TITLE       GENERAL, DOB & DEMOLITION NOTES
	WINDOW NUMBER 3 ROOM NAME OFFICE DOOR INDICATOR	ZONING DISTRICT         000         BLOCK         000           ZONING MAP         000         LOT         000           SEAL & SIGNATURE         DATE         05/14/2024           JOB NO.:         0141           SCALE:         12" = 1'-0"           DRAWING NO.:         GOO01.000
		© BOWERBIRD ARCHITECTS 2022 - DO NOT SCALE FROM DRAWINGS

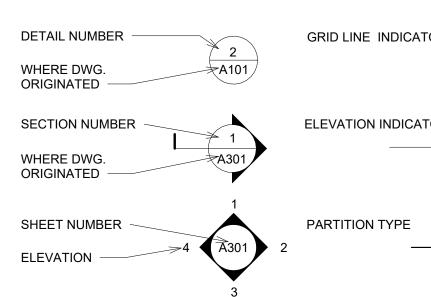

	264 TACONIC RD.
Vicinity Map Scole: 1"=1,500'	264 TACONIC RD. SALISBURY, CT 06068         Architect         Daniel Kaplan, RA         Bowerbird Architects, PLLC         124 9th St. Suite 250         Brooklyn NY 11215         Tel: 917.447.7855         Owner         AREK FEREDJIAN & ELINA TUNYAN         Code Consultant         Code Cunsultant Name
Legend	and Address           Structural Engineer           Structural Engineer Name           and Address
Image: Property Line       Monument         Gasement Line       Iron Pin, Pipe, Rebar, Drill Hole         Index Contour       O       Calculated Property Corner         Intermediate Contour       WF-6       Wetland Flag         Intermediate Contour       Image: Sign       Sign         Iedge/Shrub Line       ×234.0       Existing Spot Grade         Itone Wall       Image: Sign       Malibox         Itone Wall       Image: Sign       Malibox         Iedge of Wall       Image: Sign       Malibox         Ience       -0-       Utility Pole         Itream/Edge of Water       Image: Lamp Post       Lamp Post         Imit of Wetlands       N/F       Now or Formerly (in Title of)         Ipland Review/Regulated Area       Image: Sign       Image: Sign	PROGRESS SET 05/14/2024
RELIMINARY 01/22/2021	
Total Parcel Area xxxxxx S.F. xxxxx Acres	DATE REVISION
Deed References Volume xxx Page xxx & Volume xxx Page xxx GRAPHIC SCALE 0 20 40 80 160 (FEET) 1 inch = 40 ft.	PROJECT 264 TACONIC RD. SALISBURY, CT 06068 TITLE SURVEY
<section-header><section-header><section-header><section-header></section-header></section-header></section-header></section-header>	ZONING DISTRICT 000 BLOCK 000 ZONING MAP 000 LOT 000 SEAL & SIGNATURE DATE 05/14/2024 JOB NO.: 0141 SCALE: DRAWING NO.: GG004.00

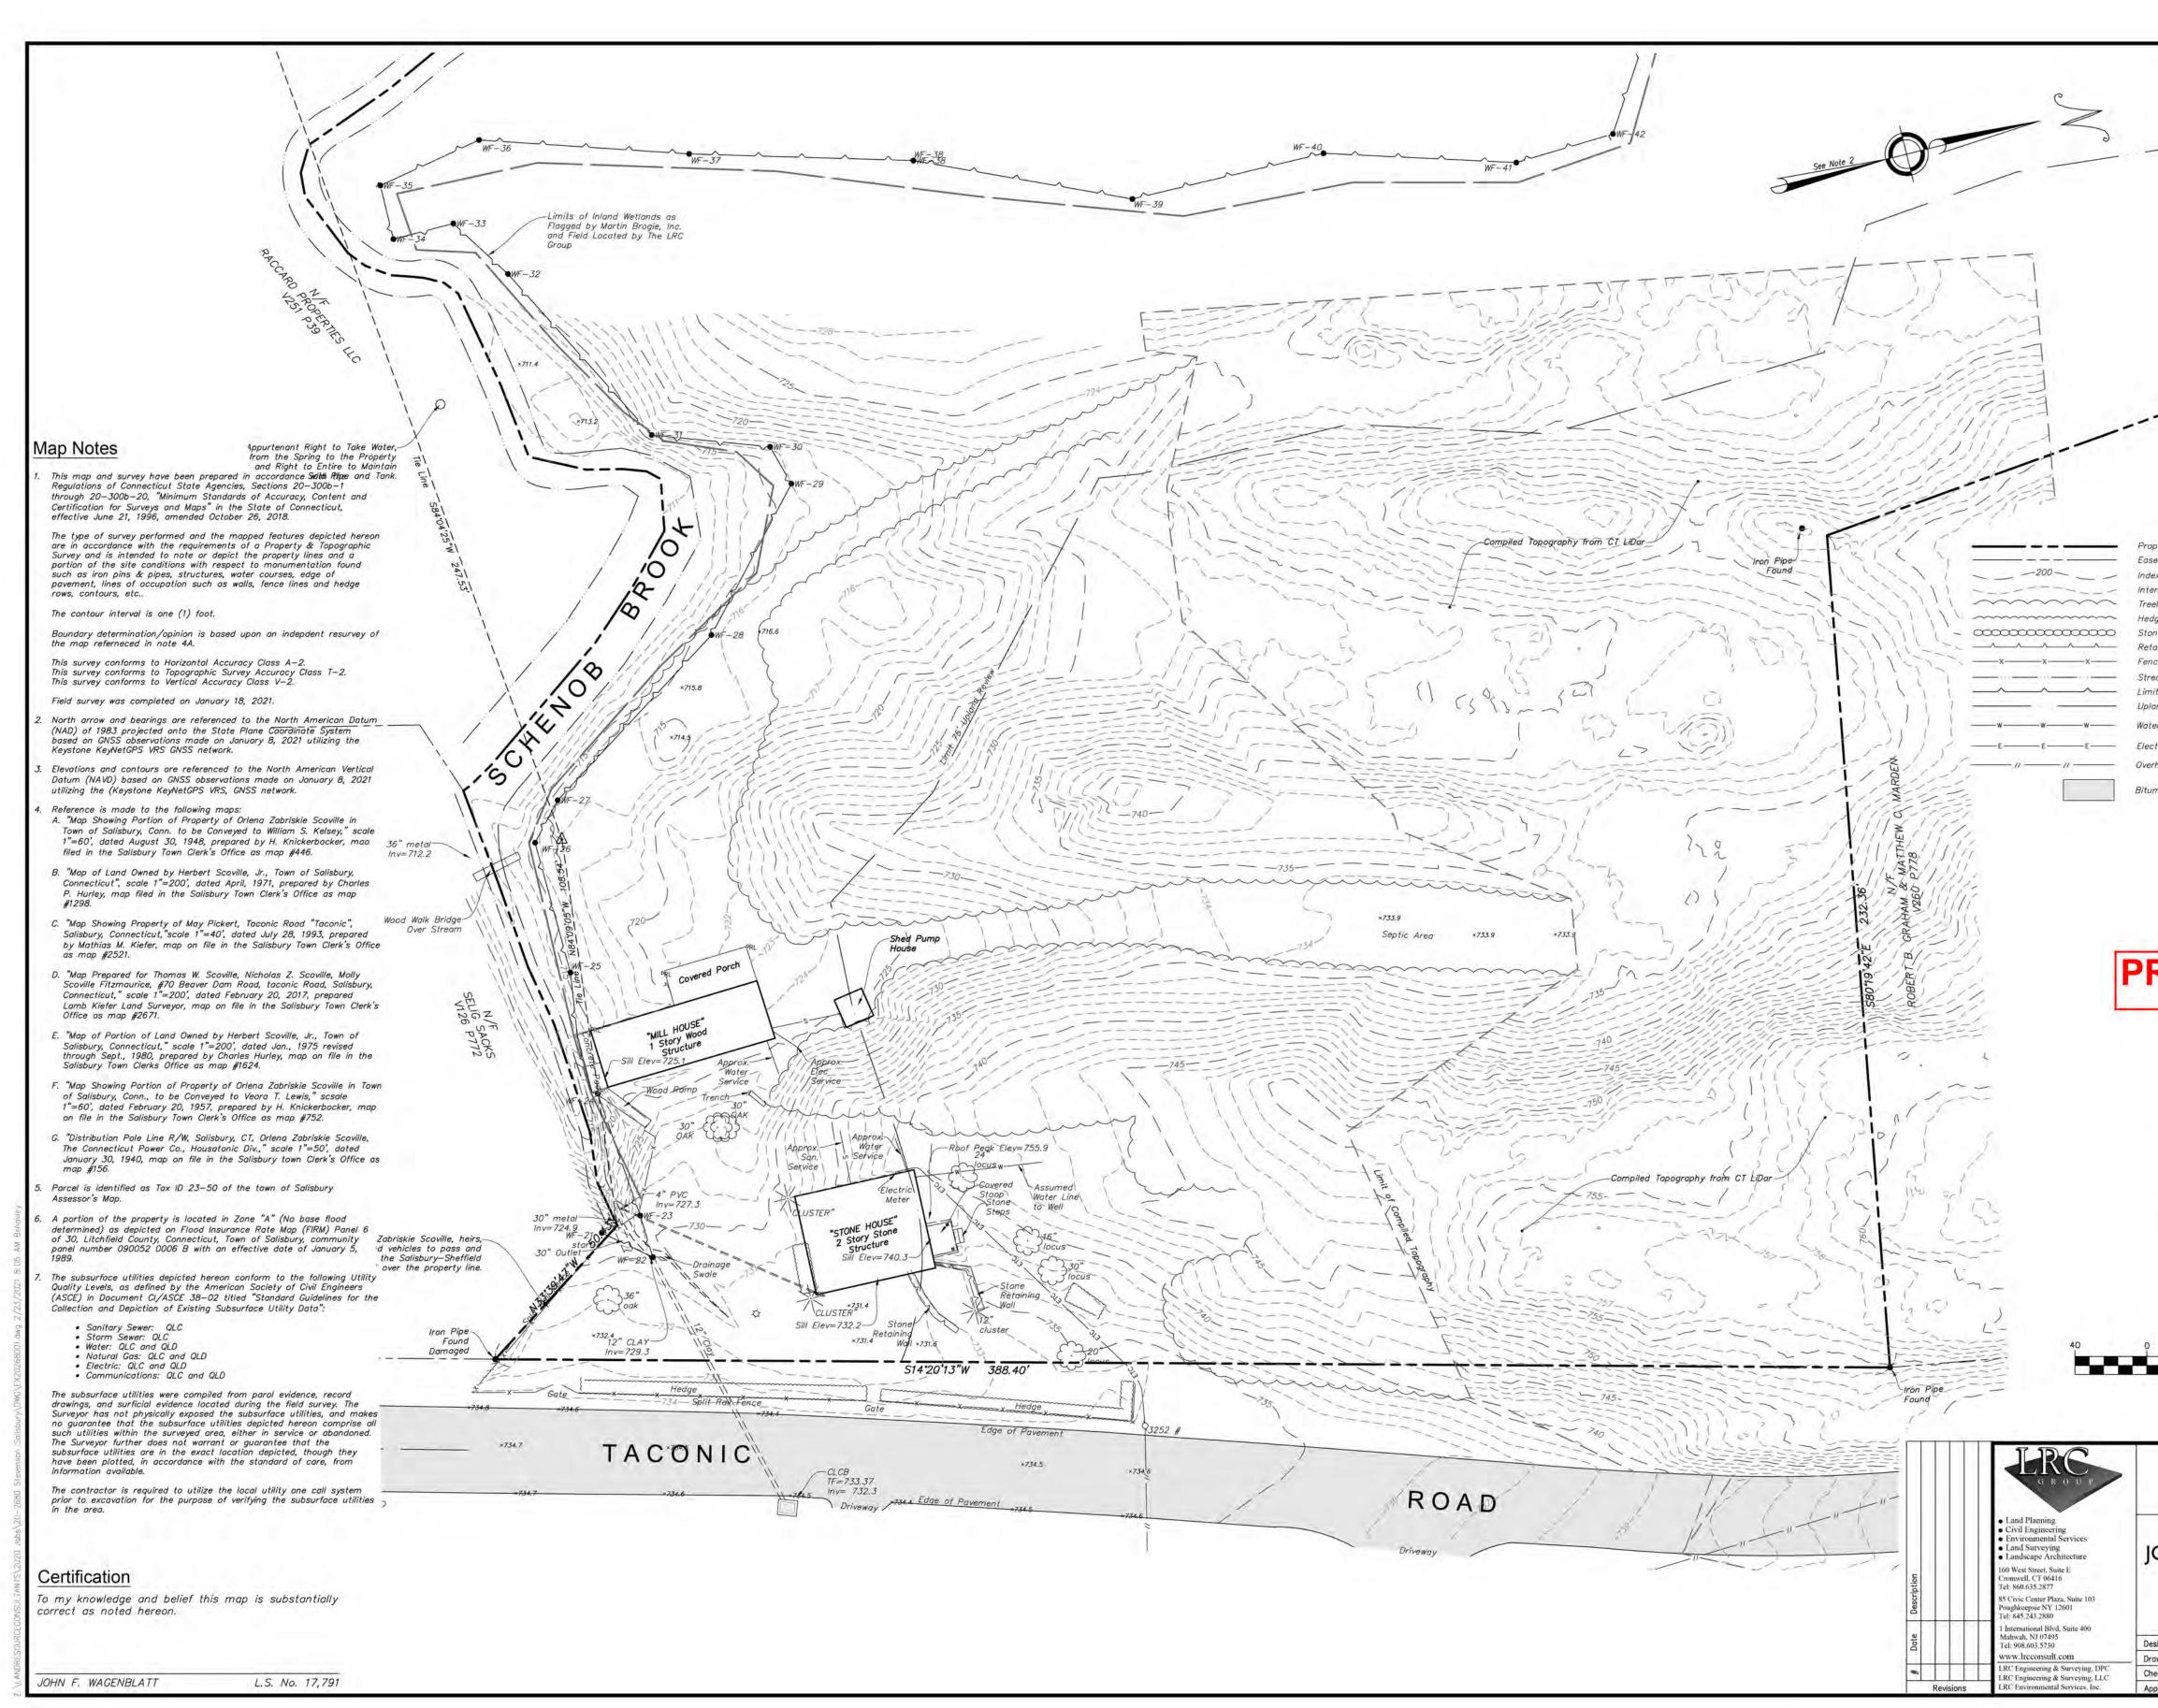

264 TACONIC RD. SALISBURY, CT 06068

Architect

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Owner


AREK FEREDJIAN & ELINA TUNYAN

Code Consultant Code Cunsultant Name and Address

Structural Engineer Structural Engineer Name and Address

## PROGRESS SET 05/14/2024

DOB EXAMINER - SEAL & SIGNATURE

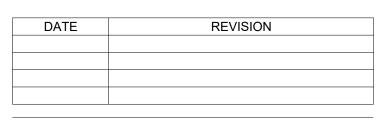

PROJECT



TITLE

### **ZONING ANALYSIS**

ZONING DISTRICT	000	BLOCK	000
ZONING MAP	000	LOT	000
SEAL & SIGNATURE		DATE	05/14/2024
		JOB NO.:	0141
		SCALE:	As indicated
		DRAWING NO .:	
		Z100	0.00

# TABLE R-VALUES

	ITEM	R-VALUE
	CONCRETE 60 POUNDS PER CUBIC FOOT AT 1" THICKNESS	
	CONTINUOUS RIGID POLYSTYRENE (EXTRUDED)	5 PER INCH
	CONTINUOUS SEMI-RIGID STONE WOOL	4.3 PER INCH
	OPEN CELL SPRAY FOAM INSULATION	3.5 PER INCH
	CLOSED CELL SPRAY FOAM	6.5 PER INCH
· · · · · · · · · · · · · · · · · · ·	5/8" SHEETROCK FIRECODE C CORE POIL BACKED GYP. BD.	0.45
<u> 288 (128</u> )	STUCCO	0.2 PER INCH
	5/8" DENSEGLASS SHEATING	0.67
	AIR GAP	1

# TABLE 2021 IECC

	CHAPTER R4 RESIDEN	ITIAL ENERGY EFFICIENCY - CLI	MATE ZONE 5
DET	TABLE R402.1.3 INSULATIO AILS SEE SHEET EN002.00 FOR TYPICAL FLOOR, F	ON AND FENESTRATION REQUIREMENTS B OUNDATION AND WALL DETAILS, SEE SHE	
ITEM	ITEM DESCRIPTION	PROPOSED DESIGN VALUE	CODE VALUE AND CITATION (ZONE)
1	FENESTRATION U-FACTOR	U-0.30	U-0.30 (Zone 5)
2	SKYLIGHT U-FACTOR	U-0.55	U-0.55 (Zone 5)
3	GLAZED FENESTRATION SHGC	0.40	0.40 (Zone 5)
4	CEILING R-VALUE	R-60	R-60 (Zone 5)
5	WOOD FRAME WALL R-VALUE	R-32.5	R-30 OR R-13 + 10ci (Zone 5)
6	MASS WALL R-VALUE	N/A	R-13 / 17 (Zone 5)
7	FLOOR R-VALUE	N/A	R-30 (Zone 5)
8	BASEMENT WALL R-VALUE	N/A	R-15ci (Zone 5)
9	SLAB R-VALUE & DEPTH	R-10ci	R-10ci, 4 FEET (Zone 5)
10	CRAWL SPACE WALL R-VALUE	N/A	R-15ci (Zone 5)
11	PIPE	R-3	R-3 (R403.4)
12	LIGHTING	100% OF LIGHTING FIXTURES TO BE HIGH EFFICIENCY	100% HIGH EFFICIENCY (R404.1)

#### IECC COMPLIANCE STATEMENT


TO THE BEST OF MY KNOWLEDGE, BELIEF AND PROFESSIONAL JUDGMENT, THESE PLANS AND SPECIFICATIONS ARE COMPLIANCE WITH 2021 INTERNATIONAL ENERGY CONSERVATION CONSTRUCTION CODE, USING CHAPTER 4 [RE].


## ENERGY DEREGRMANCE NOTES

CODE CITATION	AS SHOWN ON PLAN SET	CODE CITATION	AS SHOWN ON PLAN SET
R401.2 Application         Residential Buildings Shall comply with R402.1.5 and R401.2.1         R401.2.1 Prescriptive Compliance Option         The prescriptive compliance option requires compliance with R401 through R404	See this schedule	<b>R403.6 Mechanical ventilation</b> The buildings complying with section R402.4.1 shall be provided with ventilation that complies with the requirements of section M1505 of the International Residential Code or International Mechanical Code, as applicable or with other approved means of ventilation. Outdoor air intakes and exhausts shall have automatic or gravity dampers	See proposed ERV on Mechanical plans M101.00-M102.00
<b>R401.3 Certificate</b> A permanent certificate shall be completed by the builder and installed at the location indicated on Floor Plan A101.00	See note A101.00	that close when the ventilation system is not operating <b>R403.7 Equipment sizing and efficiency rating</b> Heating and cooling equipment shall be sized in accordance with ACCA Manual S based on building loads calculated in accordance with ACCA Manual J or other approved	See HVAC notes on Mechanical Plans M101.00 and M102.00
<b>R402.1.1 Vapor Retarder</b> Wall assemblies in the building thermal envelope shall comply with the vapor retarder requirements of R702.7 of the international residential code per wall assembly details on	See Wall, floor and roof types on sheet EN001.00	heating and cooling calculation methodologies. New or replacement heating and cooling equipment shall have an efficiency rating equal to or greater than the minimum required by federal law for the geographic location where the equipment is installed.	
<b>R402.1.3 R-Value Alternative</b> R-Values and fenestration shall meet the requirements in Table R402.1.3 as specified on this sheet.	See Wall, floor and roof types and table R402.1.3 on sheet EN001.00	<b>R403.10 Energy consumption of pools and spas</b> The energy consumption of pools and permanent spas shall be controlled by the requirements in section R403.10.1 through R403.10.3	See note on A102.00
<b>R402.1.5 Additional Energy Efficiency</b> According to section <i>R408.2.2 More efficient HVAC equipment performance option 2</i> a greater or equal to 10HSPF/16SEER air source heat pump is installed	See Mechanical Equipment schedule on M101.00	R403.5 Lighting Equipment All permanent installed lighting fixtures shall contain only high efficacy lighting sources	Electrical Legend note 4 on E101.00 and E102.00
<b>R402.2 Specific Insulation Requirements</b> Insulation shall meet specific requirements of Section R402.2.1 through R402.2.12	See construction details on A501.00 - A503.00		
<b>R402.4 Air Leakage</b> The building thermal envelope shall be constructed to limit air leakage in accordance with the requirements of Sections R402.4.1 through R402.4.5.	See construction details on A501.00 - A503.00		
<b>R402.4.1.2 Testing</b> The building or dwelling unit shall be tested and verified as having an air leakage rate not exceeding three air changes per hour. Testing shall be conducted in accordance with ASTM E 779 or ASTM E 1827 and reported at a pressure of 0.2 inch w.g. (50 Pascals).	THE HOUSE WILL REQUIRE A BLOWN DOOR TEST AT COMPLETION OF WORK		
<b>R402.4.3 Fenestration Air Leakage</b> Windows, skylights and sliding glass doors shall have an air infiltration rate of no more than 0.3 cfm per square foot (1.5 L/s/m2), and swinging doors no more than 0.5 cfm per square foot (2.6 L/s/m2), when tested according to NFRC 400 or AAMA/WDMA/CSA 101/I.S.2/A440 by an accredited, independent laboratory and listed and labeled by the manufacturer.	See note on A601.00		
<b>R403.1 Controls</b> At least one thermostat shall be provided for each separate heating and cooling system.	See mechanical plans on M101.00 and M101.00		
<b>R403.1.1 Programmable Thermostat</b> The thermostat controlling the primary heating or cooling system of the dwelling unit shall be capable of controlling the heating and cooling system on a daily schedule to maintain different temperature set points at different times of the day and different days of the week. This thermostat shall include the capability to set back or temporarily operate the system to maintain zone temperatures down to 55°F (13°C) or up to 85°F (29°C). The thermostat shall initially be programmed by the manufacturer with a heating temperature set point no higher than 70°F (21°C) and a cooling temperature set point no lower than 78°F (26°C).	See notes about smart thermostat on mechanical plans on M101.00 and M102.00		
<b>R403.1.2 Heat Pump Supplementary Heat</b> Heat pumps having supplementary electric-resistance heat shall have controls that, except during defrost, prevent supplemental heat operation when the heat pump compressor can meet the heating load.	No electric resistance heat proposed. See note 7 on Mechanical Plans M101.00 and M102.00		
<b>R403.2 Hot water boiler temperature reset</b> The manufacturer shall equip each gas, oil and electric boiler (other than a boiler equipped with a tankless domestic water heating coil) with automatic means of adjusting the water temperature supplied by the boiler to ensure incremental change of the inferred heat load will cause an incremental change in temperature of the water supplied by the boiler. This can be accomplished with outdoor reset, indoor reset or water temperature sensing.	See note on P101.00		
<b>R403.3 Ducts</b> Ducts and air handlers shall be installed in accordance with sections R402.3.1 through R403.3.7	See HVAC notes on Mechanical Plans M101.00 and M102.00		
<b>R403.4 Mechanical System Piping Insulation</b> Mechanical system piping capable of carrying fluids above 105°F (41°C) or below 55°F (13°C) shall be insulated to a minimum of R-3.	See HVAC notes on Mechanical Plans M101.00 and M102.00		
<b>R403.5 Service Hot Water Systems</b> Energy conservation measures for service hot water systems shall be in accordance with Sections R403.5.1. through R403.5.3	See water riser diagram on P101.00 and plumbing notes on P102.00		


## WALL, FLOOR AND ROOF TYPES


2	COMPL	

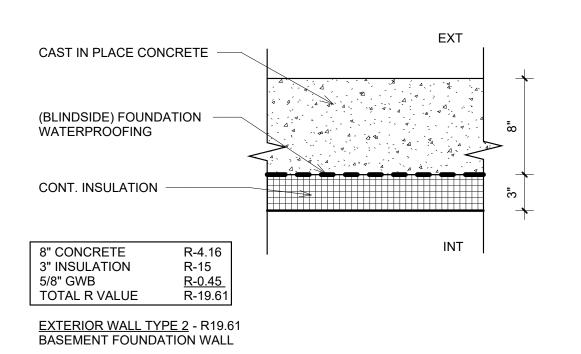

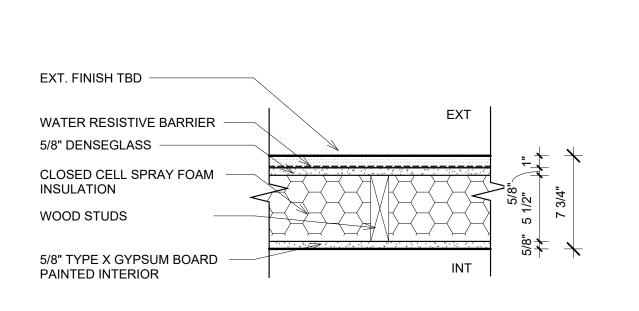

EXTERIOR WALL TYPE 3 - R32.5 (R6.5 X 5")

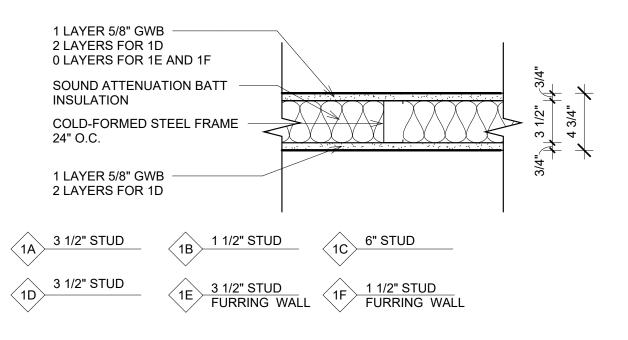

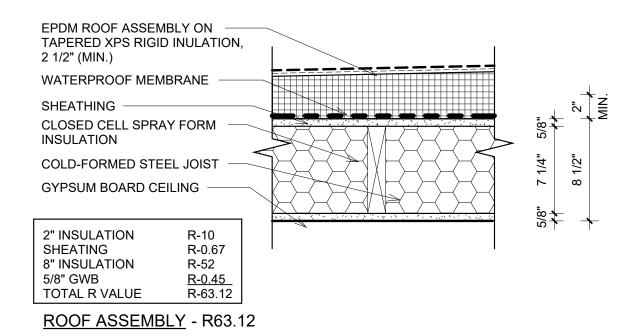

FINISH WOOD FLOORING
5" THK CLOSED CELL SPRAY — FORM INSULATION
WOOD JOIST
GYPSUM BOARD CEILING

FLOOR ASSEMBLY - R-32.5 (R-6.5 X 5")

## 264 TACONIC RD.

264 TACONIC RD. SALISBURY, CT 06068

Architect

Daniel Kaplan, RA Bowerbird Architects, PLLC 124 9th St. Suite 250 Brooklyn NY 11215 Tel: 917.447.7855

Owner


AREK FEREDJIAN & ELINA TUNYAN

Code Consultant Code Cunsultant Name and Address

Structural Engineer Structural Engineer Name and Address

#### PROGRESS SET 05/14/2024

DOB EXAMINER - SEAL & SIGNATURE

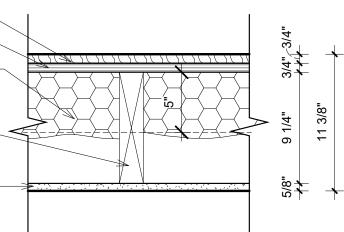

DATE REVISION

PROJECT




TITLE

ENERGY CODE REQUIREMENTS

ZONING DISTRICT	000	BLOCK	000
ZONING MAP	000	LOT	000
SEAL & SIGNATURE		DATE	05/14/2024
		JOB NO.:	0141
		SCALE:	As indicated
		DRAWING NO .:	
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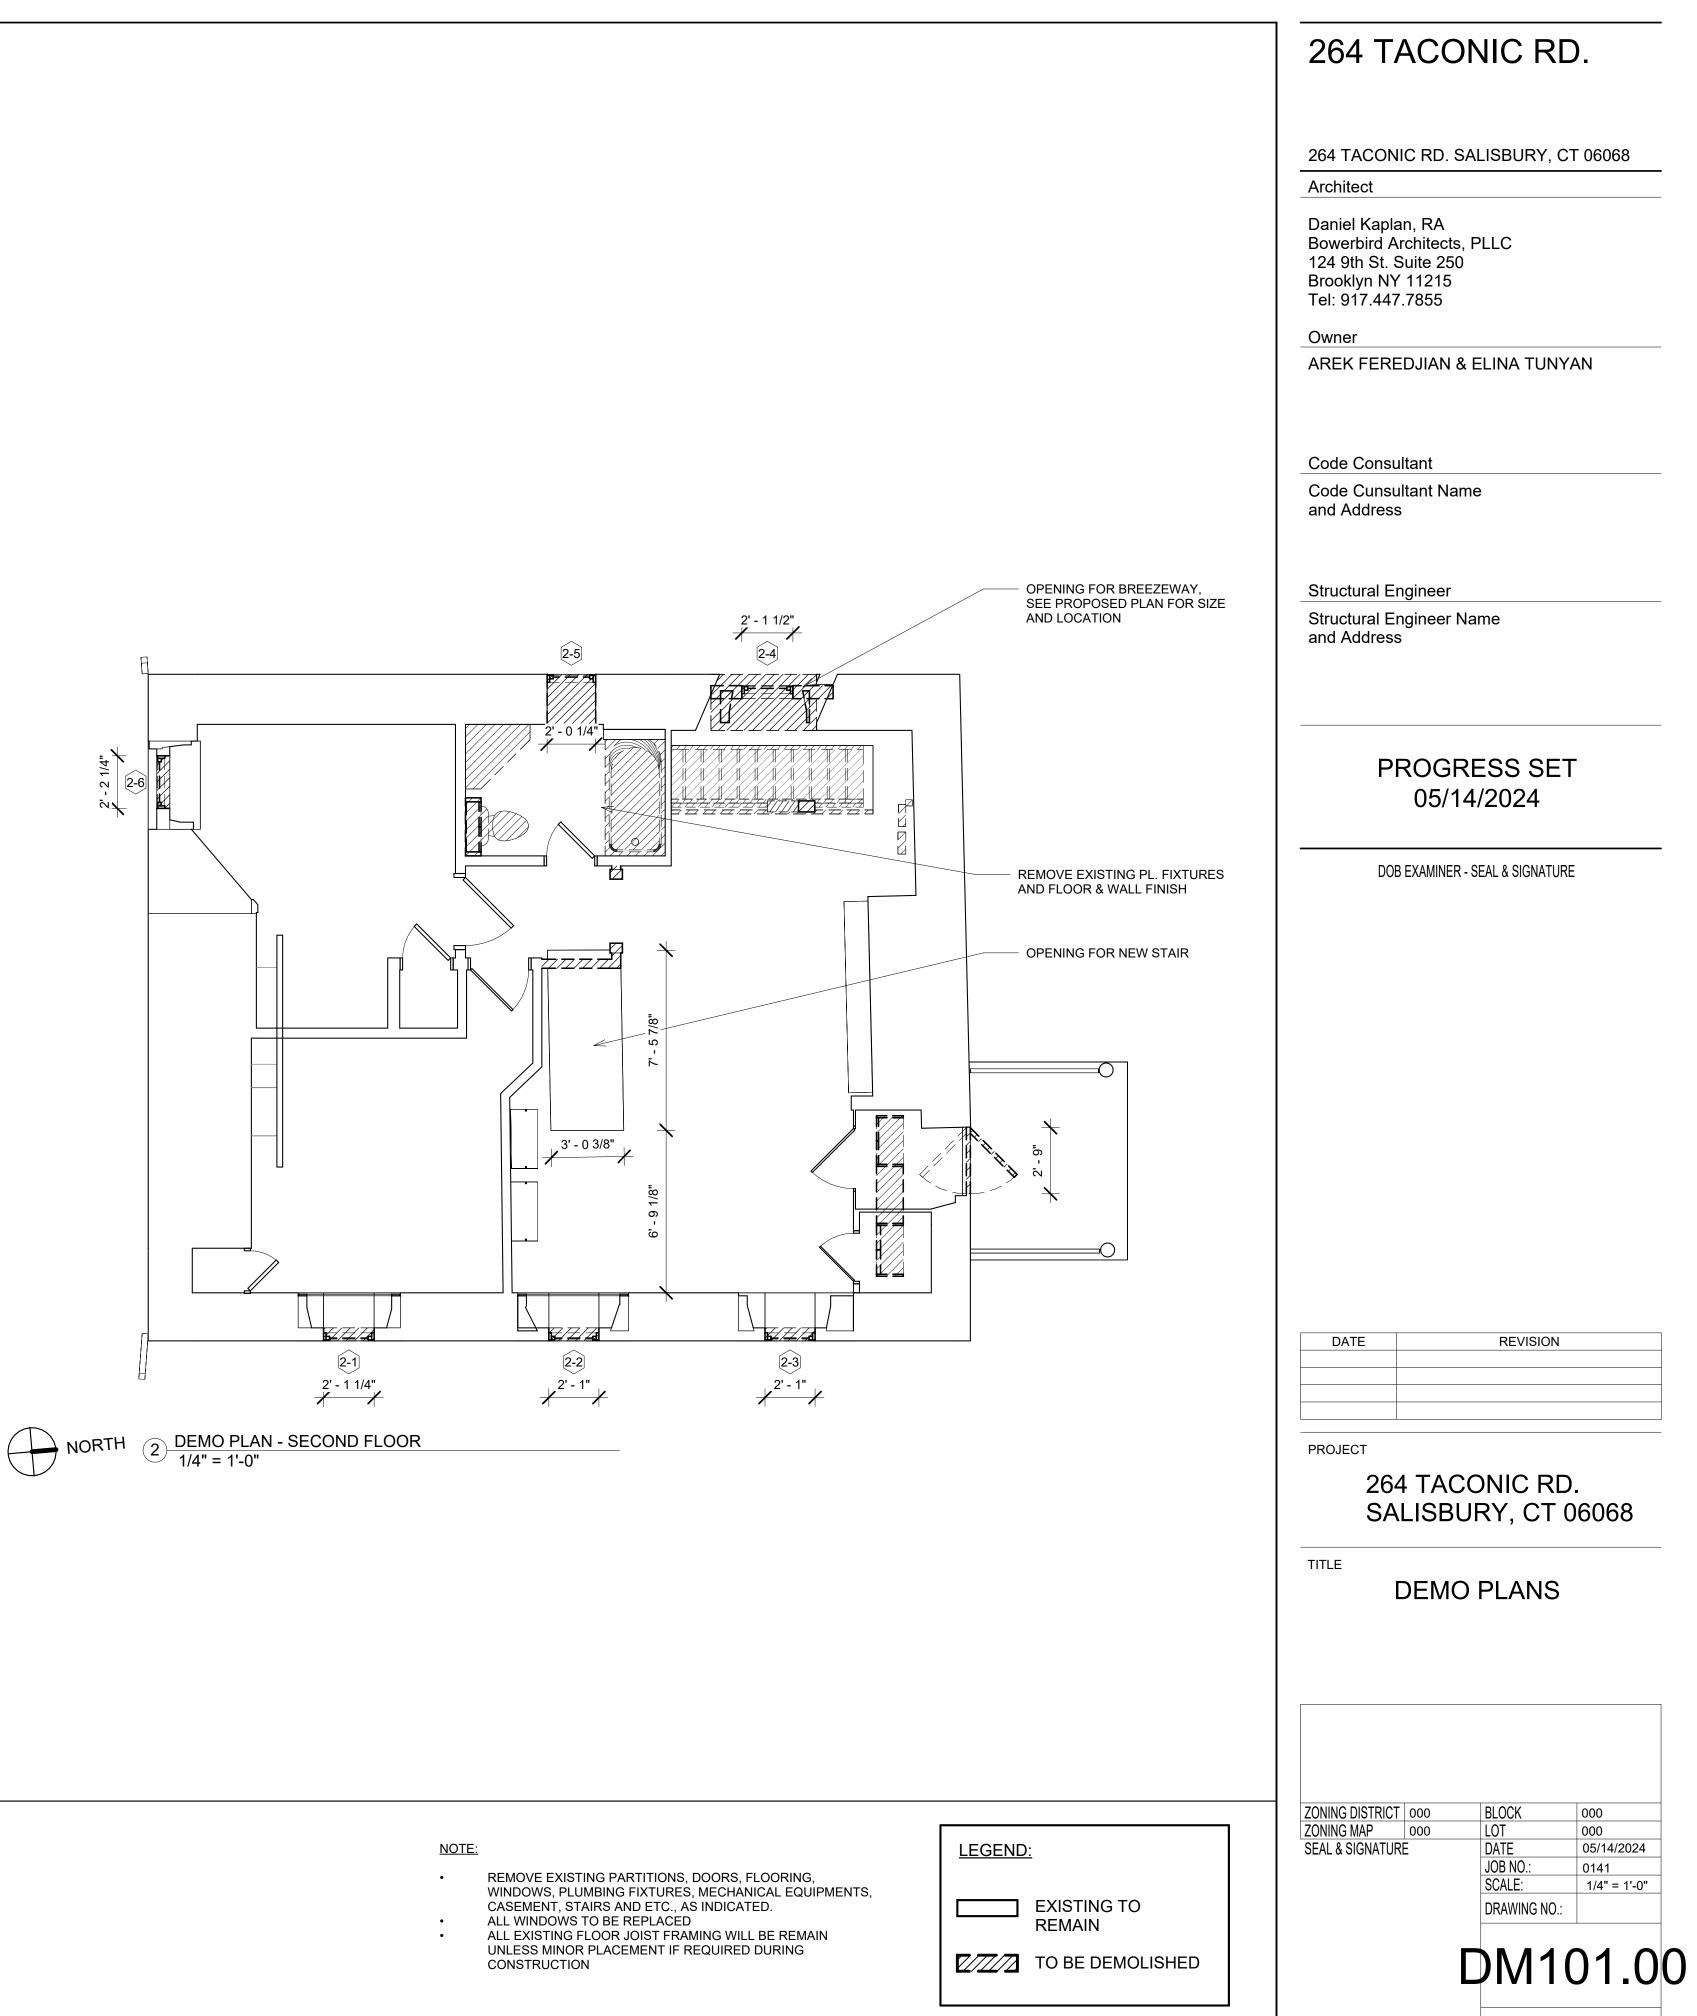
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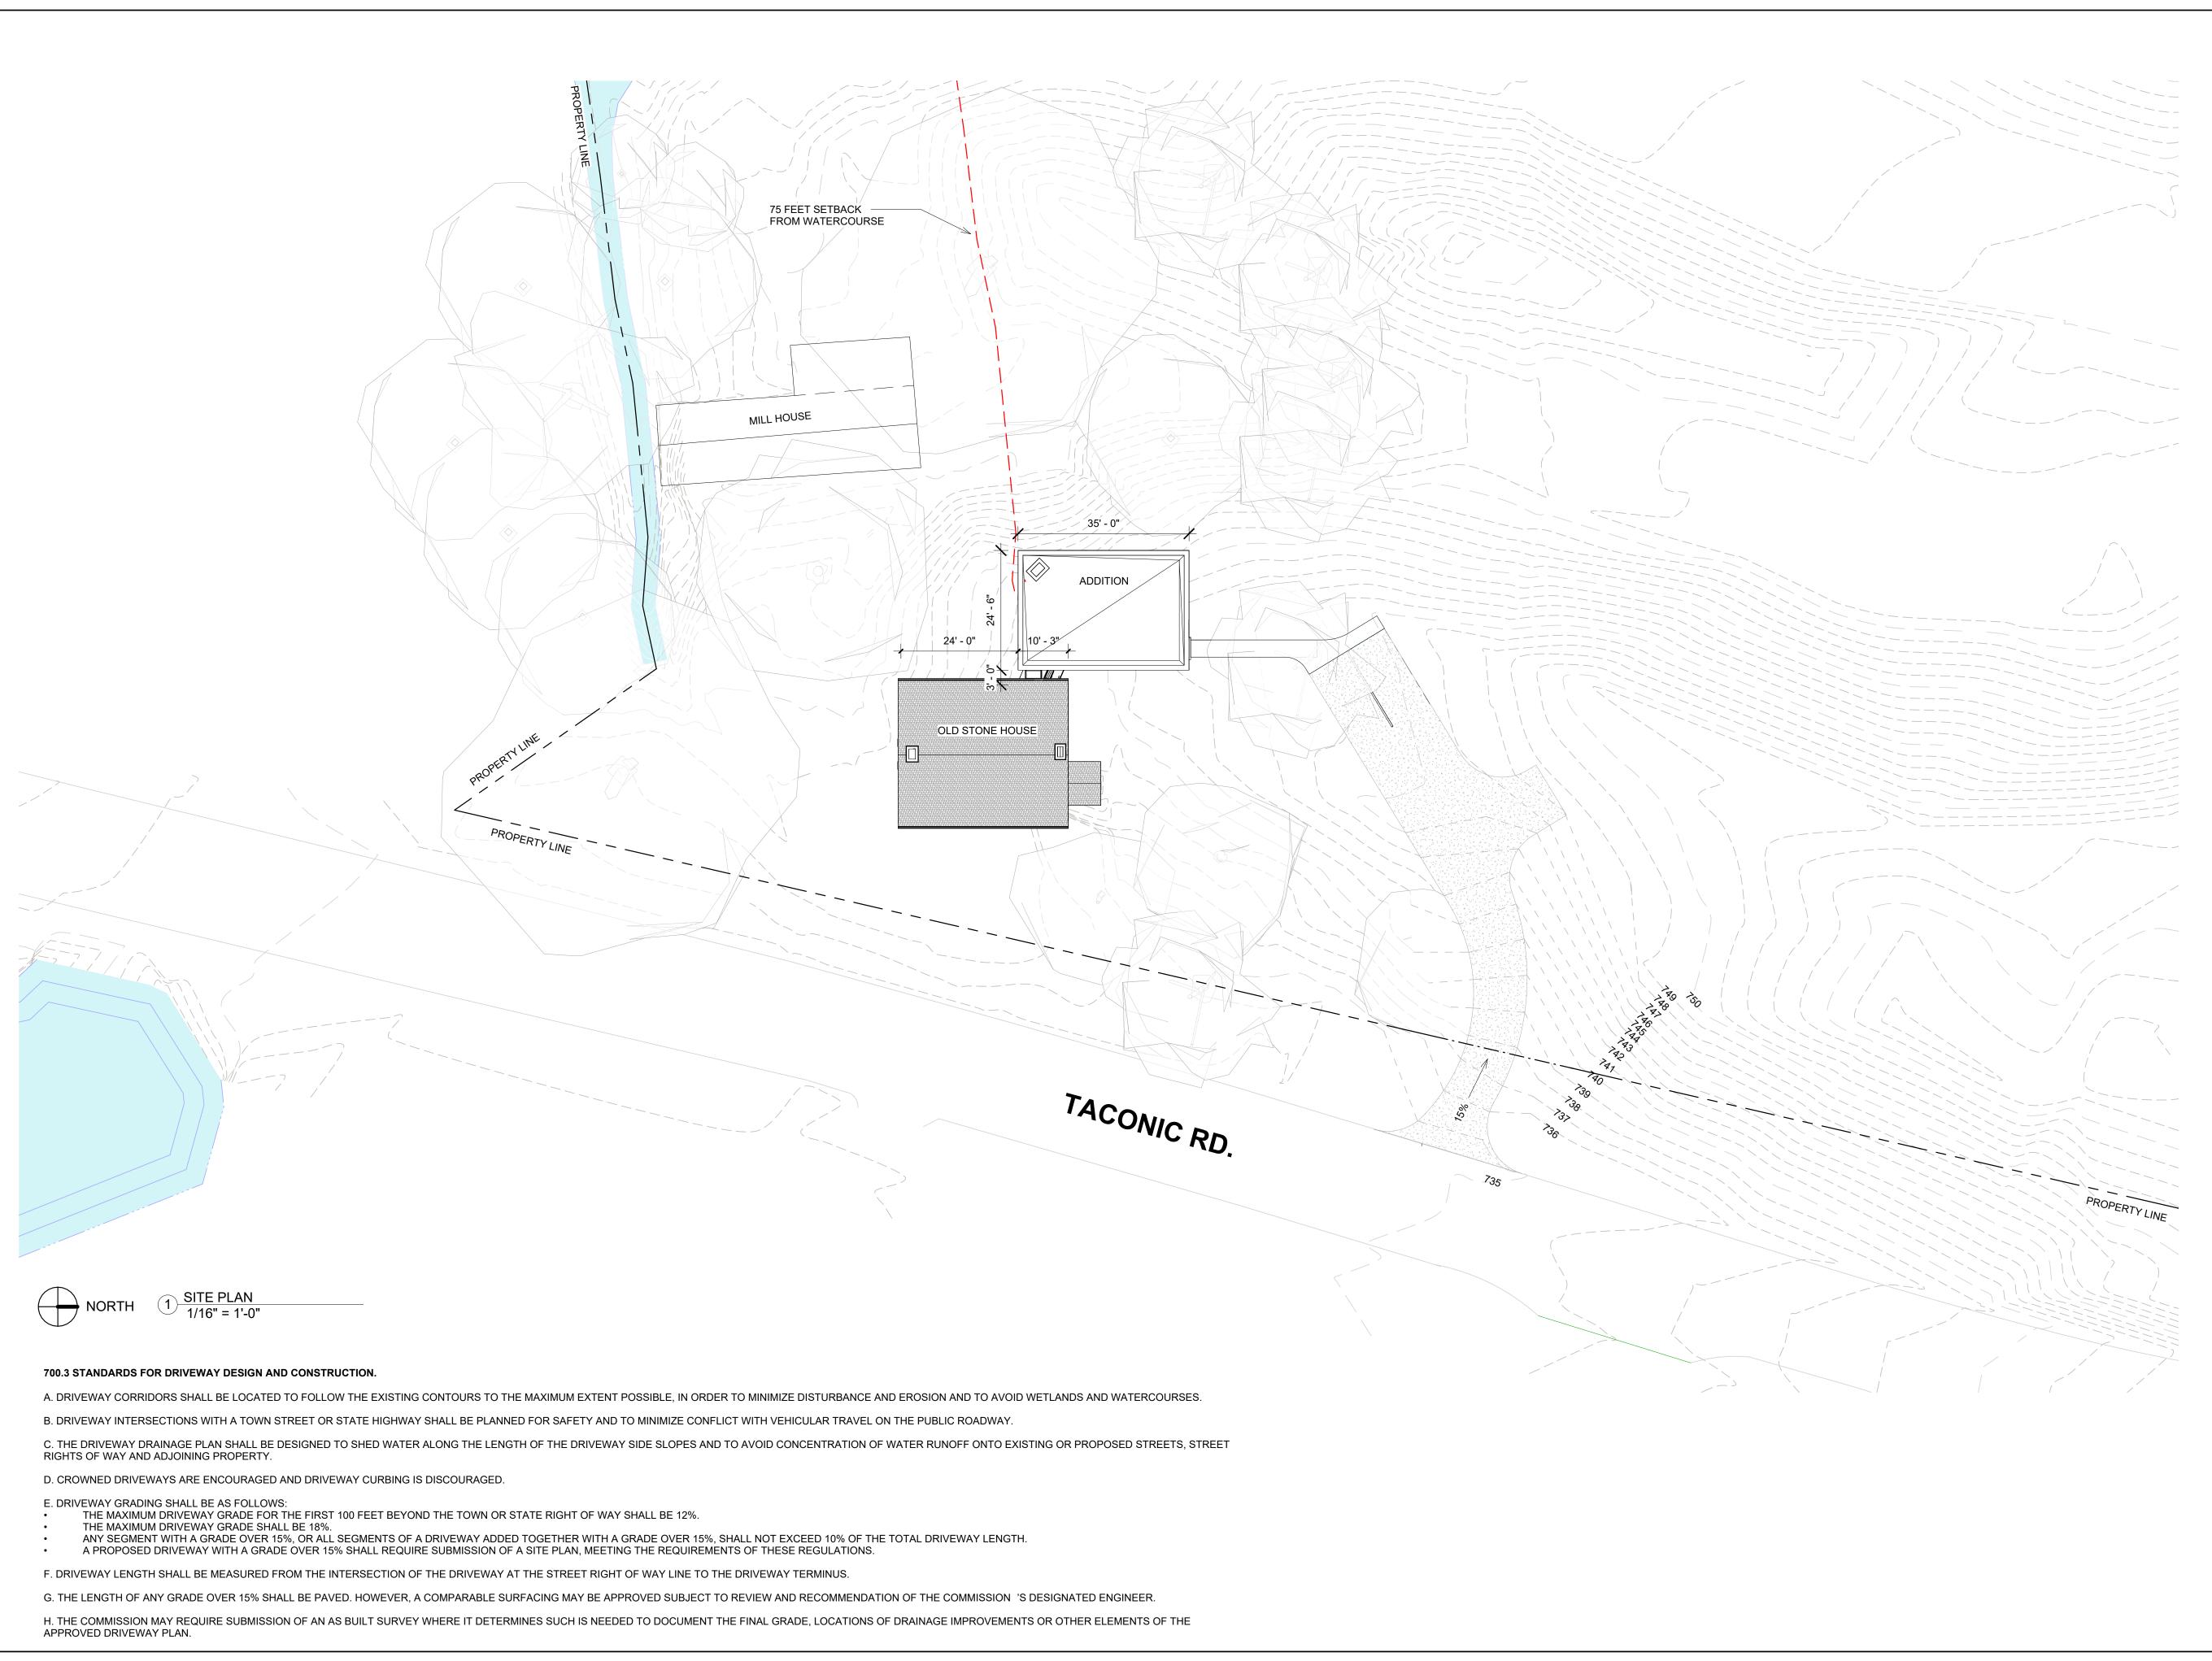


#### REMOVE EXISTING STAIR AND INFILL THE FLOOR OPENING.
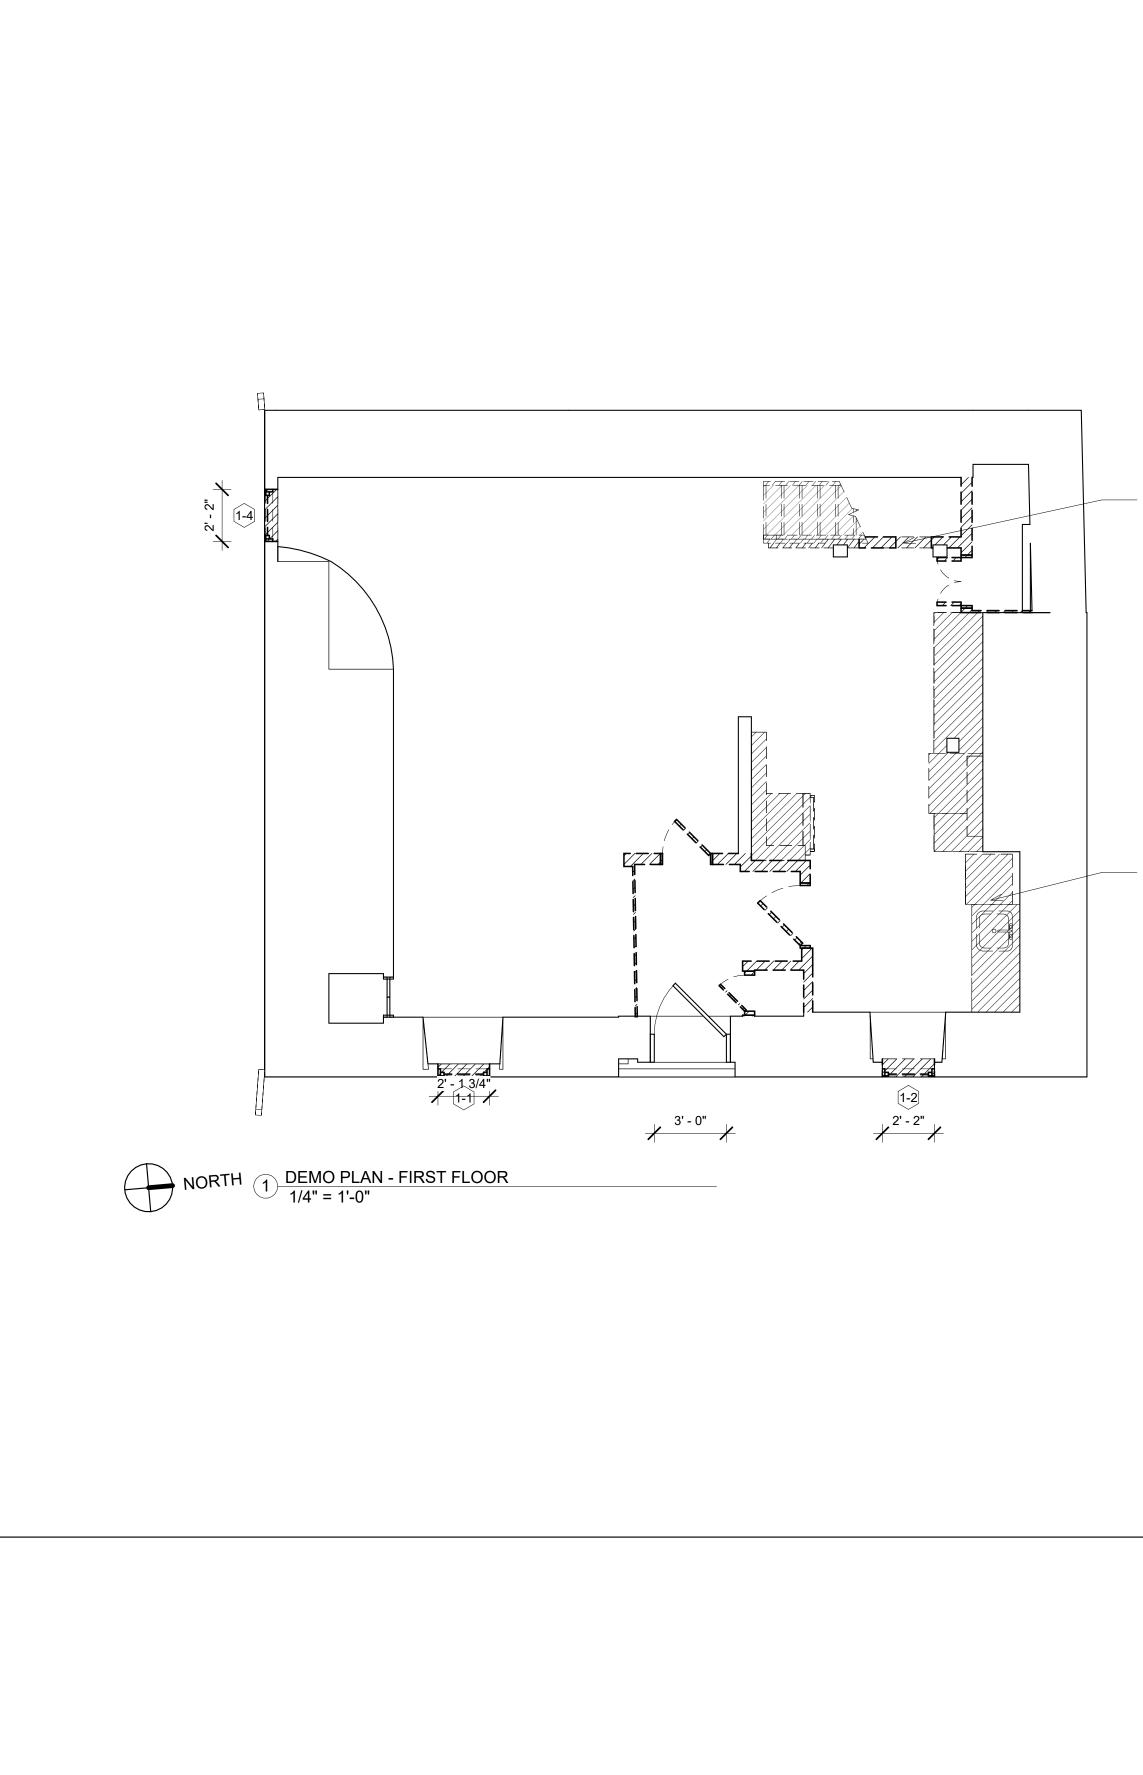
#### REMOVE EXISTING PL. FIXTURES,

AND CABINETRY.





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DOB EXAMINER - SEAL & SIGNATURE

DATE	REVISION
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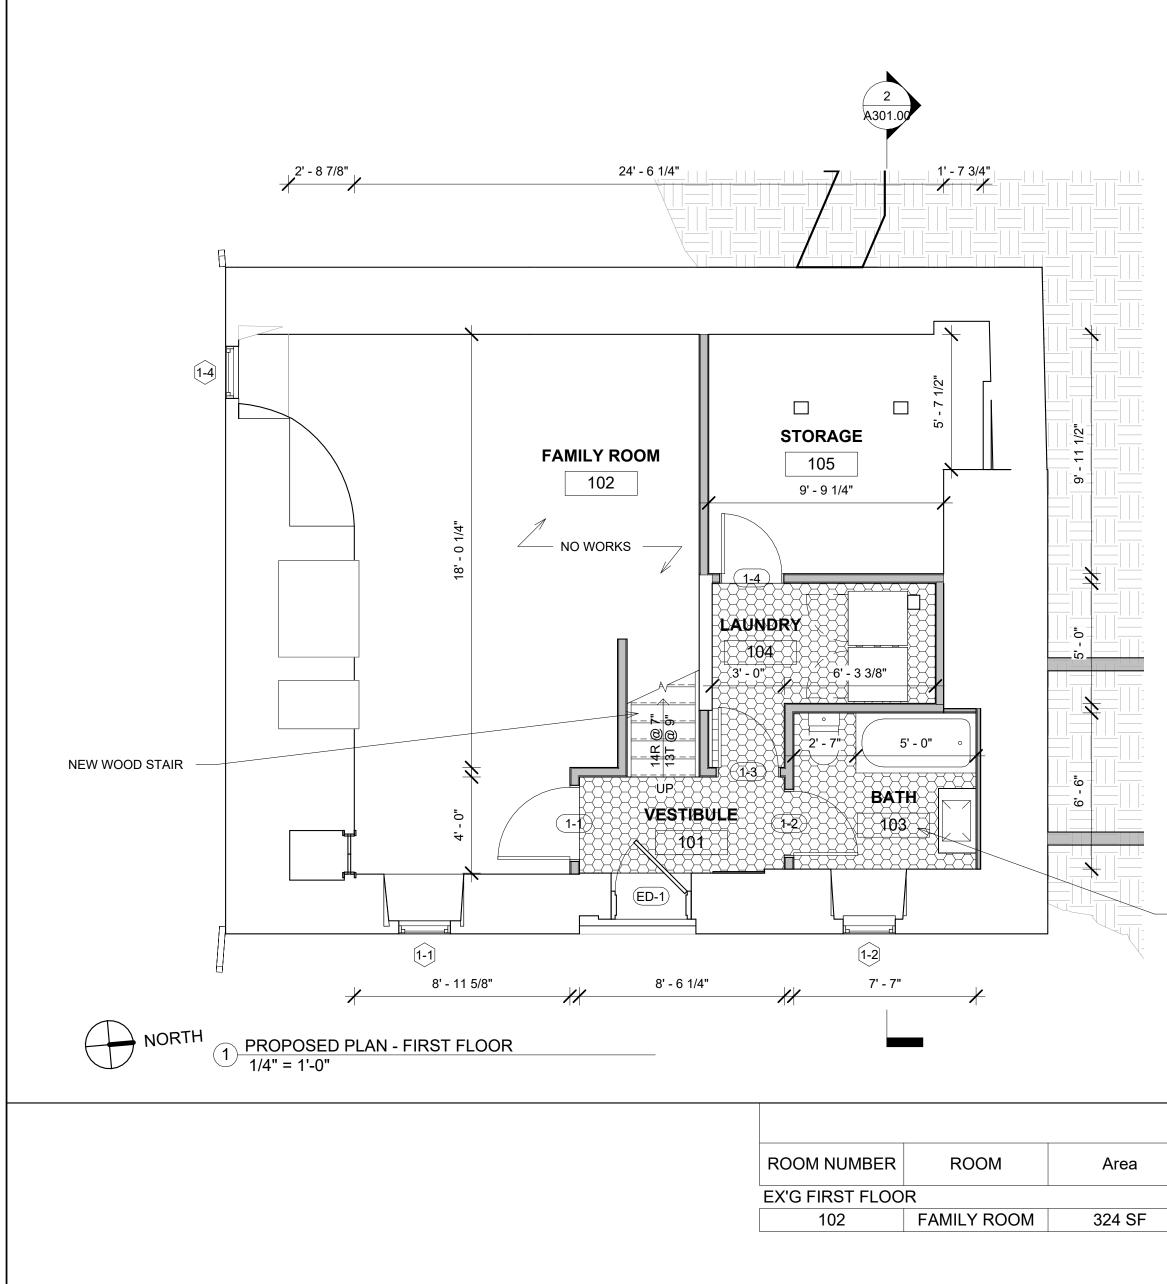
### 264 TACONIC RD. SALISBURY, CT 06068

TITLE

#### SITE PLAN

ZONING DISTRICT	000	BLOCK	000
ZONING MAP	000	LOT	000
SEAL & SIGNATURE	=	DATE	05/14/2024
		JOB NO.:	0141
		SCALE:	1/16" =
		DRAWING NO .:	1'-0"
		A10	0.00

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 NEW PL. FIXTURES IN EXISTING LOCATIONS, NEW TILE FLOOR AND WAINSCOT.

ROOM LIGHT AND AIR SCHEDULE_FIRST FLOOR								÷
REQ. LIGHT	PROVIDED LIGHT	LIGHT COMPLIANCE	REQ. AIR	PROVIDED AIR	AIR COMPLIANCE	APP. WINDOWS AND DOOR		NEW WALL
32 SF	18 SF	No	16 SF	8 SF	No			CONDITION
								AS NOTED
								NEW TILE FL
								NEW WOOD
								NEW CONCF FLOOR
	REQ. LIGHT	REQ. LIGHT PROVIDED LIGHT	REQ. LIGHT PROVIDED LIGHT LIGHT COMPLIANCE	REQ. LIGHT PROVIDED LIGHT REQ. AIR	REQ. LIGHT PROVIDED LIGHT COMPLIANCE REQ. AIR PROVIDED AIR	REQ. LIGHT     PROVIDED     LIGHT     REQ. AIR     PROVIDED AIR     AIR       COMPLIANCE     COMPLIANCE     COMPLIANCE     COMPLIANCE     COMPLIANCE	REQ. LIGHT     PROVIDED LIGHT     LIGHT COMPLIANCE     REQ. AIR     PROVIDED AIR     AIR COMPLIANCE     APP. WINDOWS AND DOOR	REQ. LIGHT       PROVIDED LIGHT       LIGHT COMPLIANCE       REQ. AIR       PROVIDED AIR       AIR COMPLIANCE       APP. WINDOWS AND DOOR         32 SF       18 SF       No       16 SF       8 SF       No       []

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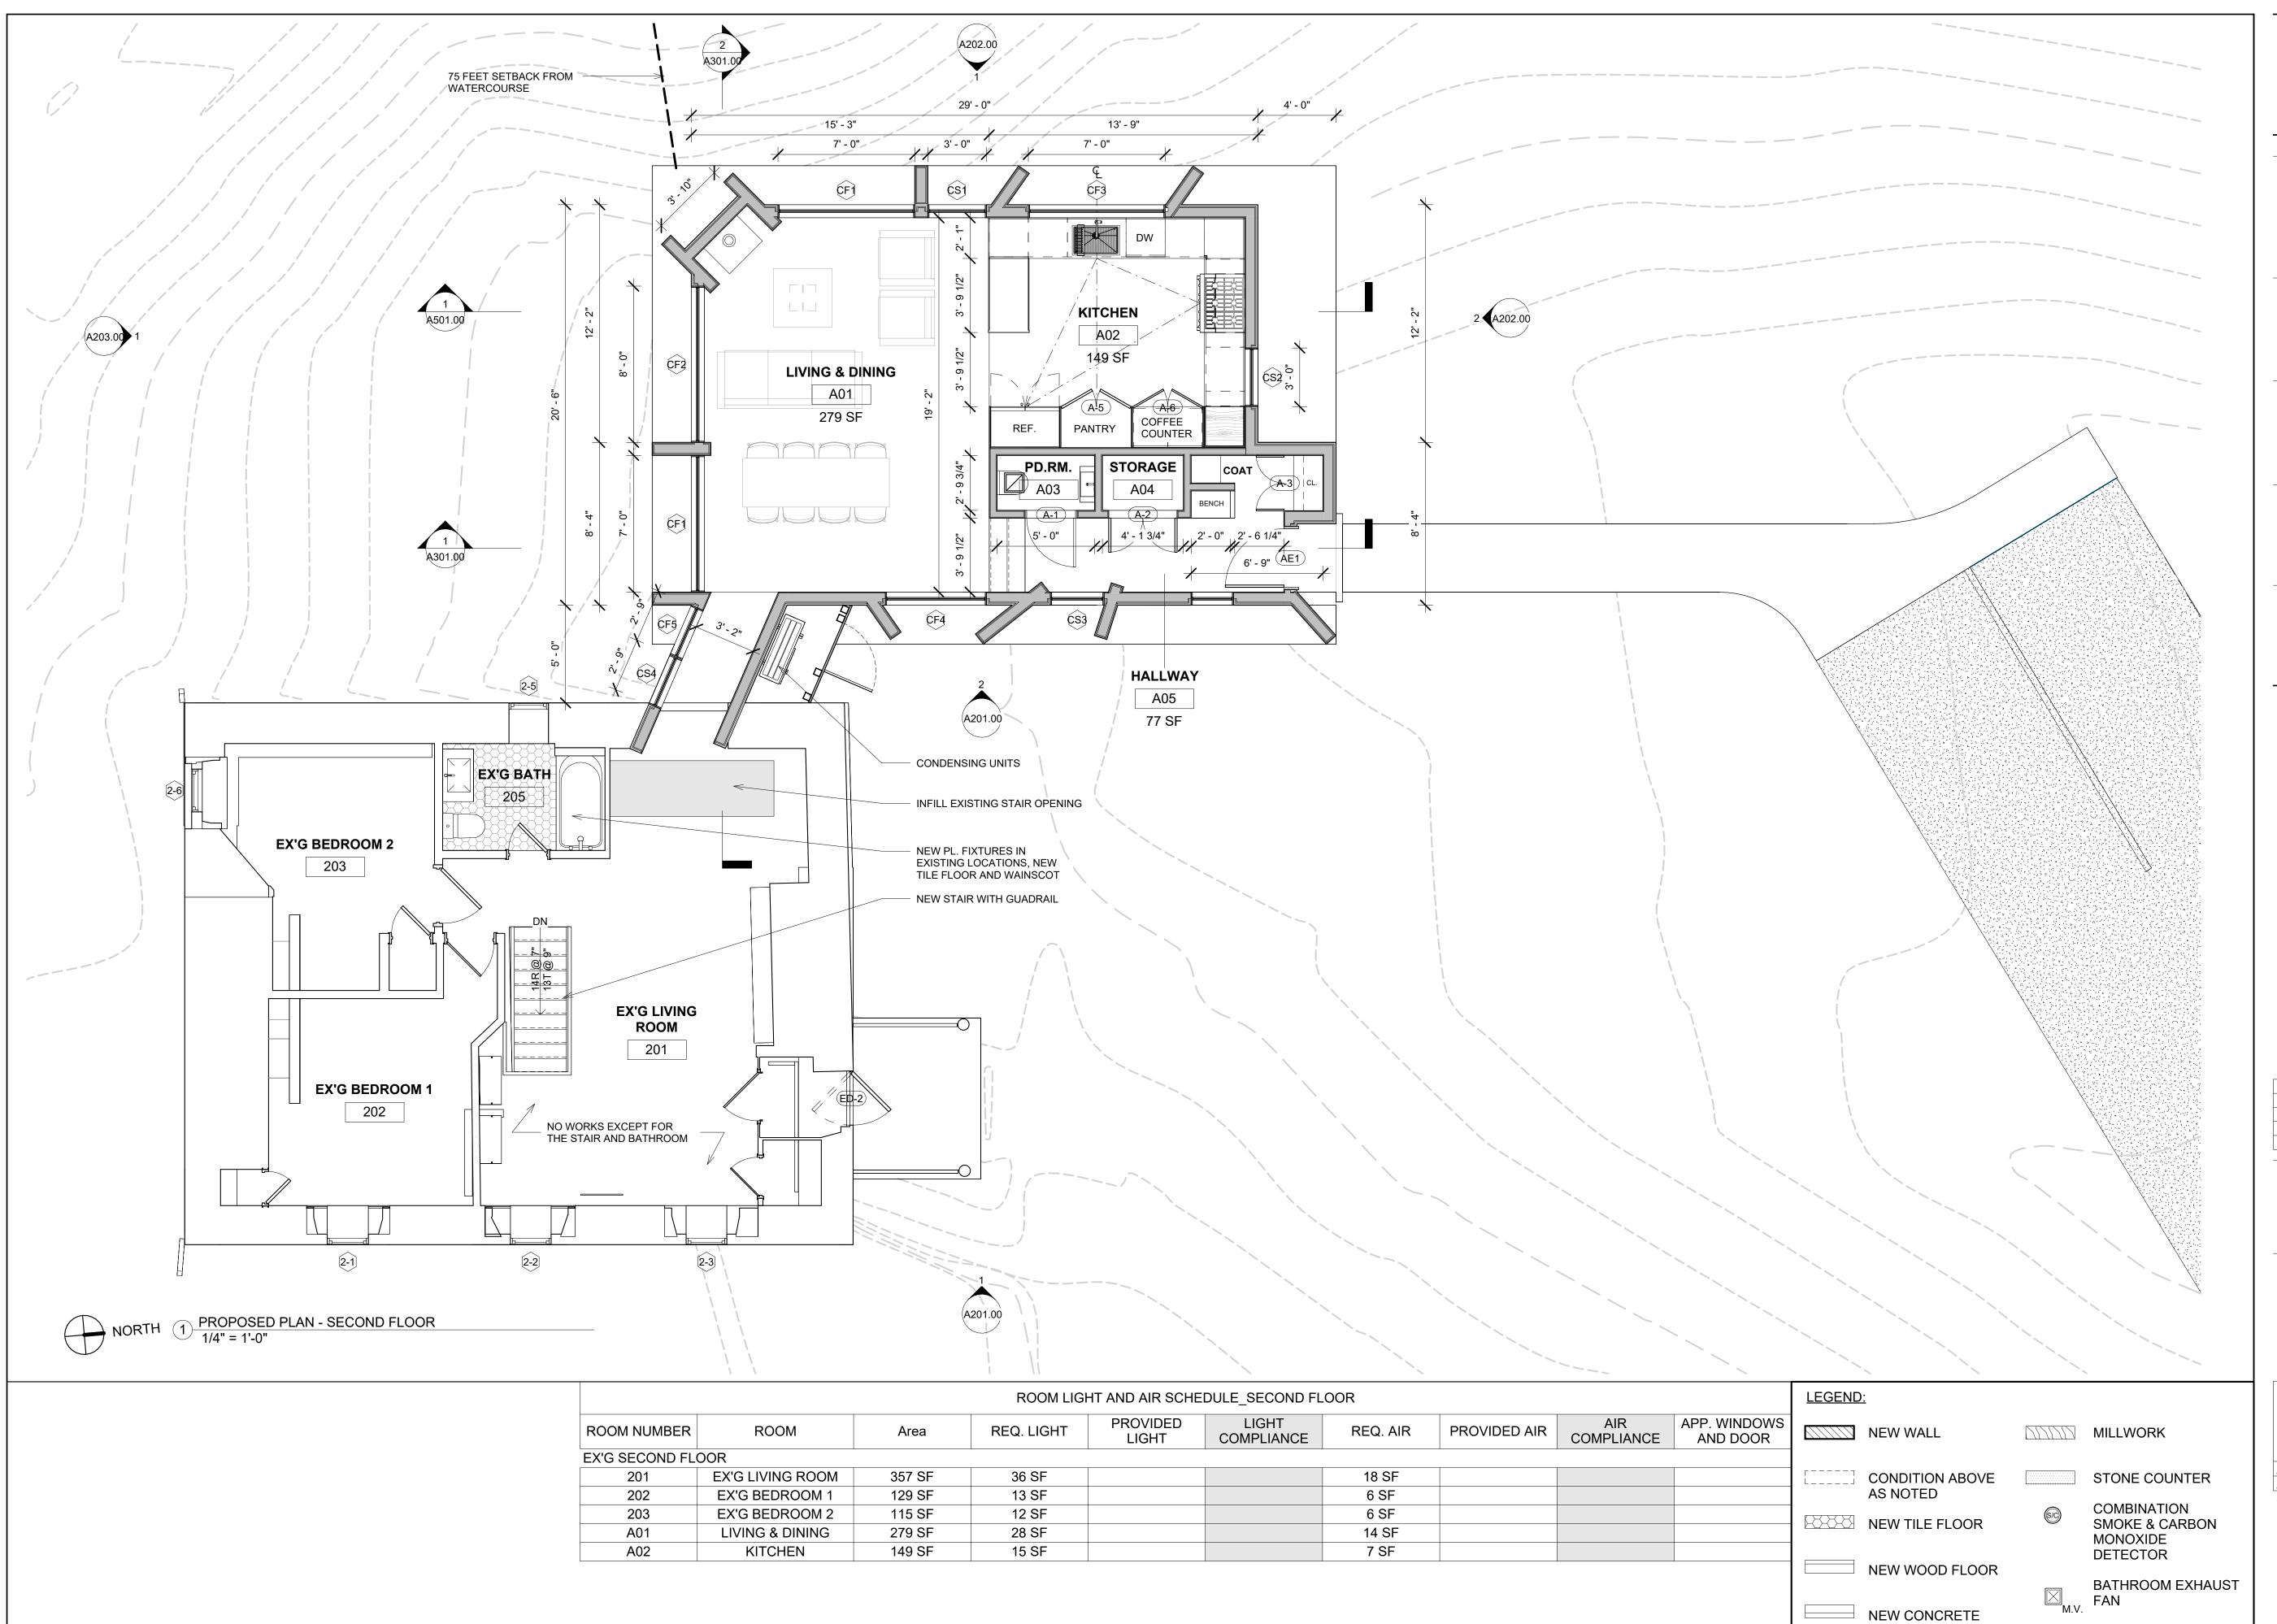
PROJECT

264 TACONIC RD. SALISBURY, CT 06068

## FLOOR PLANS - FIRST FLOOR

ZONING DISTRICT	000	BLOCK	000
ZONING MAP	000	LOT	000
SEAL & SIGNATURE		DATE	05/14/2024
		JOB NO .:	0141
		SCALE:	1/4" = 1'-0"
		DRAWING NO .:	
		A10	1.00

WALL	2000	MILLWORK
ITION ABOVE		STONE COUNTER
TILE FLOOR	60	COMBINATION SMOKE & CARBON MONOXIDE DETECTOR
NOOD FLOOR		BATHROOM EXHAUST
CONCRETE	M.V.	FAN



ROOM LIGHT AND AIR SCHEDULE_SECOND FLOOR								LEGEND	<u>:</u>
	REQ. LIGHT	PROVIDED LIGHT	LIGHT COMPLIANCE	REQ. AIR	PROVIDED AIR	AIR COMPLIANCE	APP. WINDOWS AND DOOR		NEW WAI
	36 SF			18 SF					CONDITIO
	13 SF			6 SF					AS NOTE
	12 SF			6 SF					
	28 SF			14 SF				R7273	NEW TILE
	15 SF			7 SF					
									NEW WO
									NEW CON

264 TACONIC RD. SALISBURY, CT 06068

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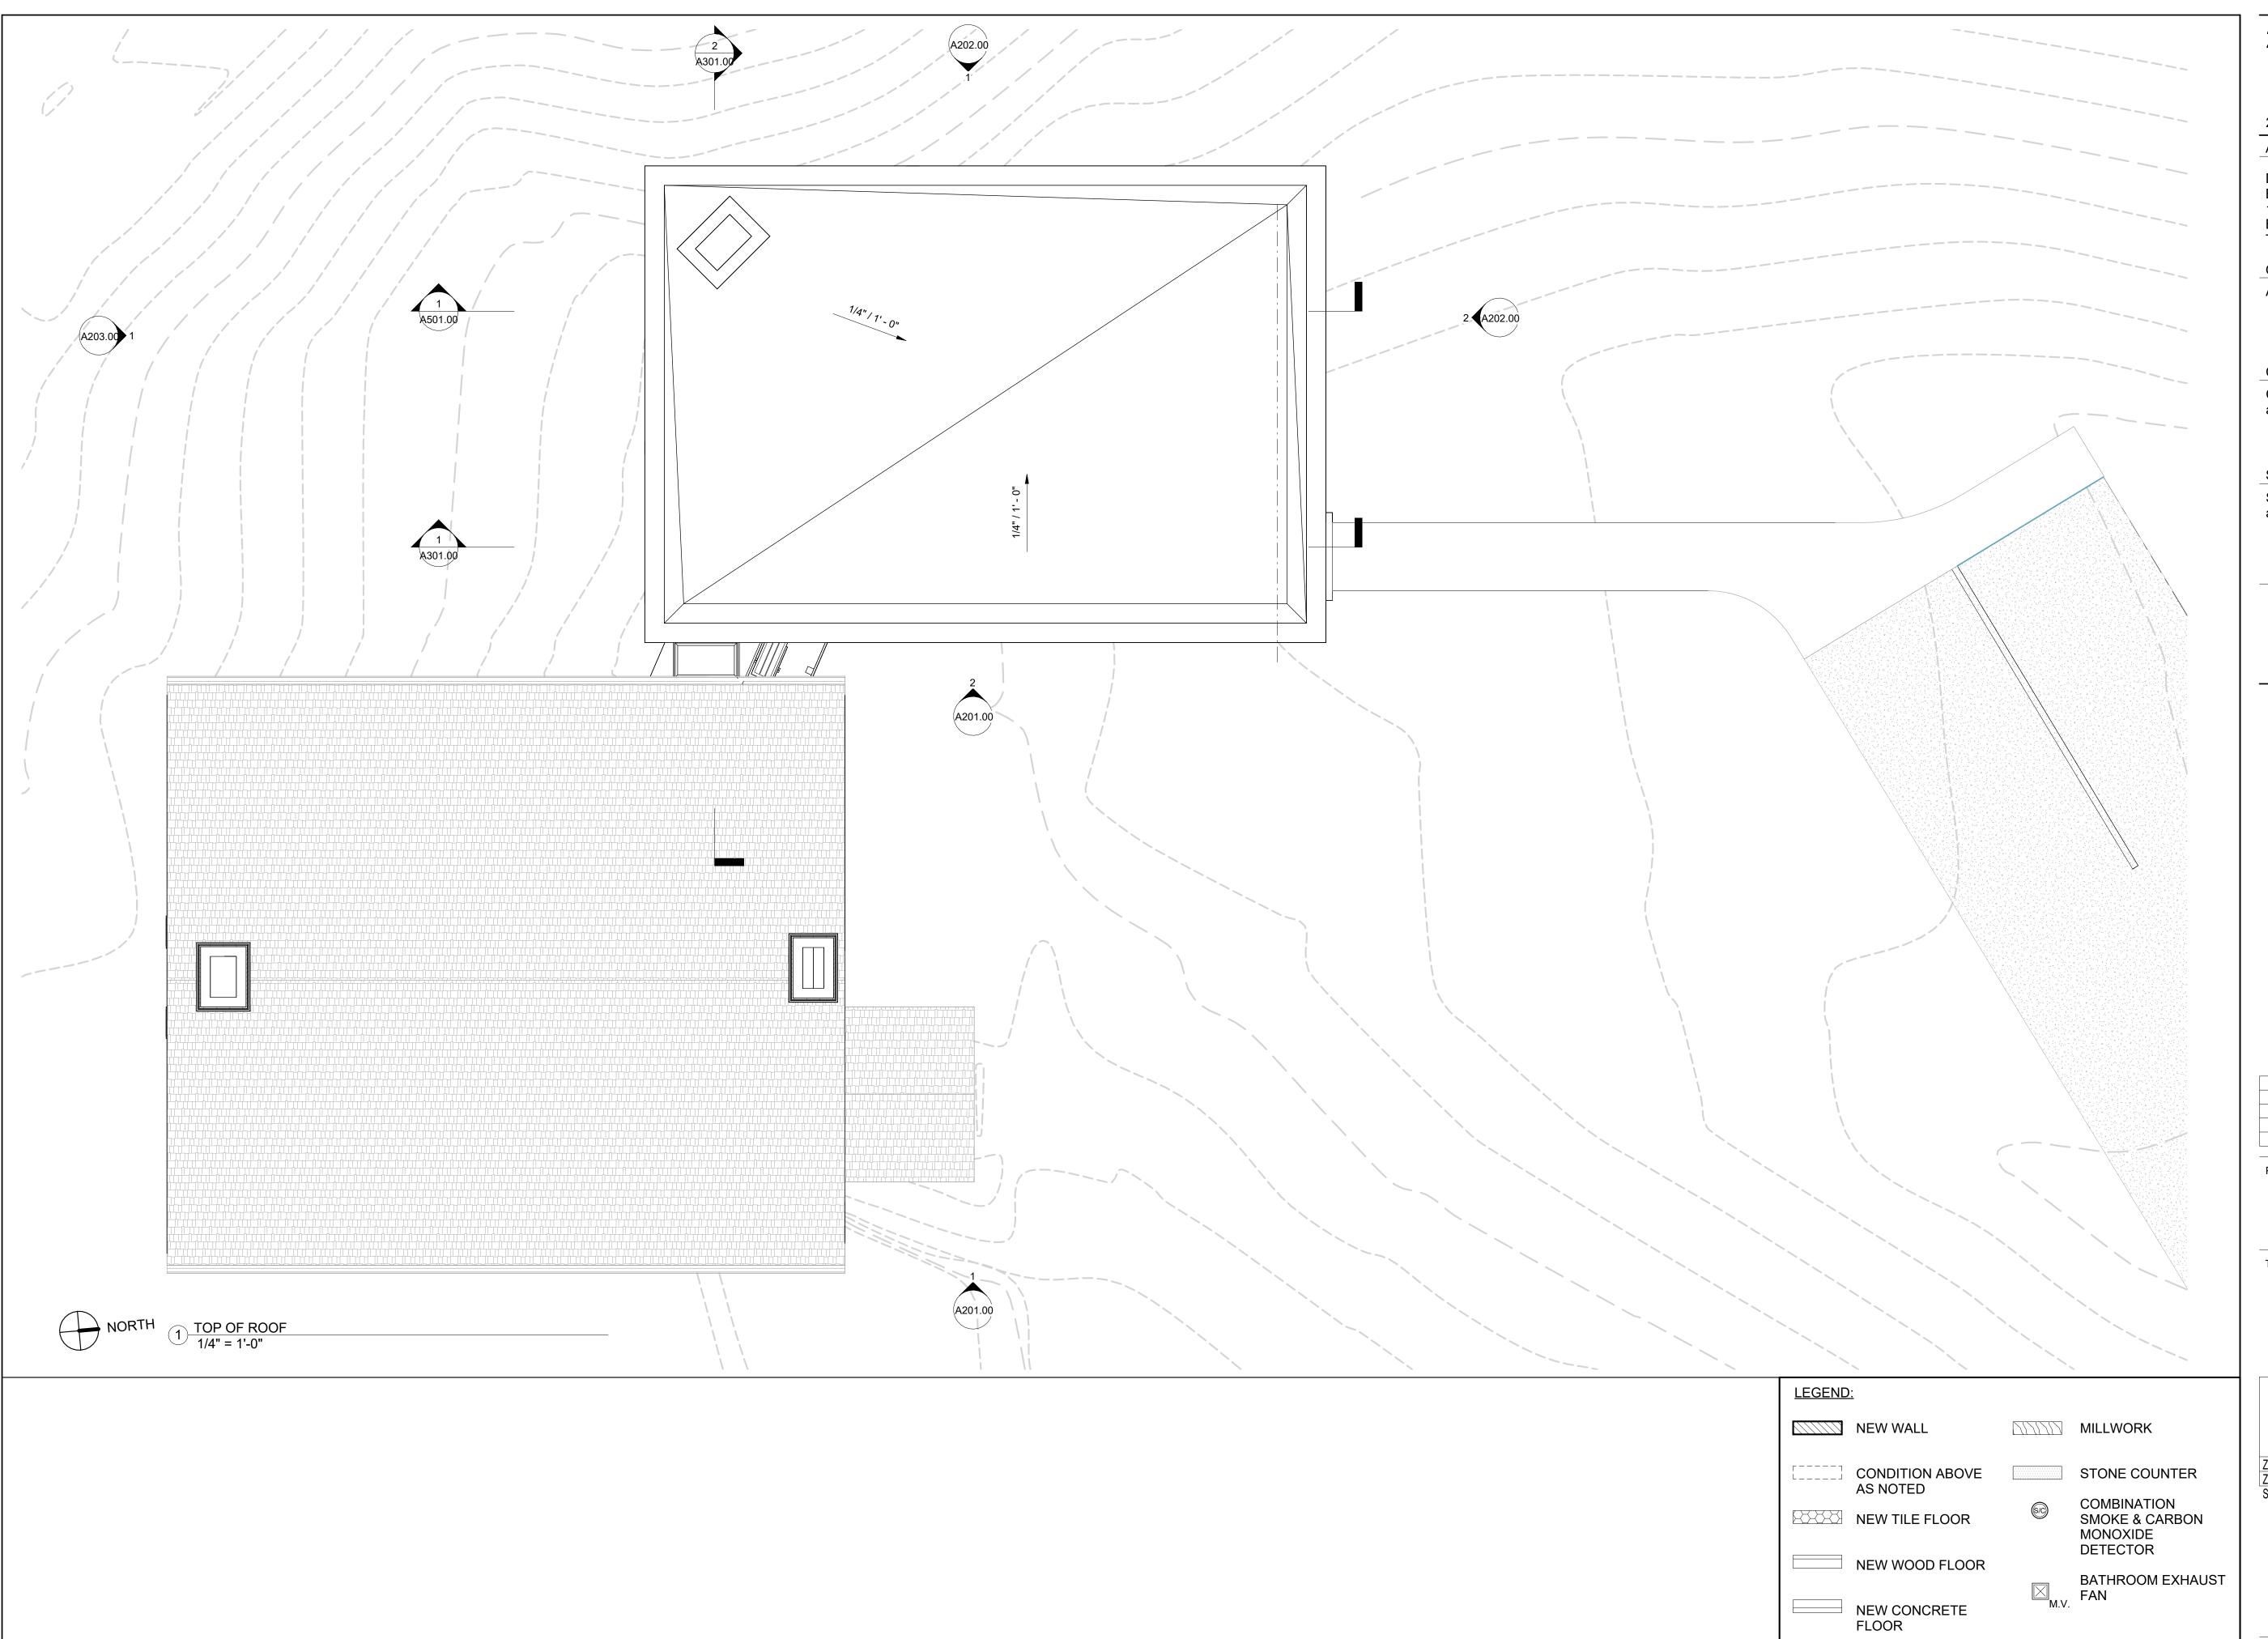
DATE	REVISION

PROJECT

## 264 TACONIC RD. SALISBURY, CT 06068

#### TITLE FLOOR- AND ROOFPLANS

000	BLOCK	000
000	LOT	000
	DATE	05/14/2024
	JOB NO .:	0141
	SCALE:	1/4" = 1'-0"
	DRAWING NO .:	
		2.00
		000 LOT DATE JOB NO.: SCALE:



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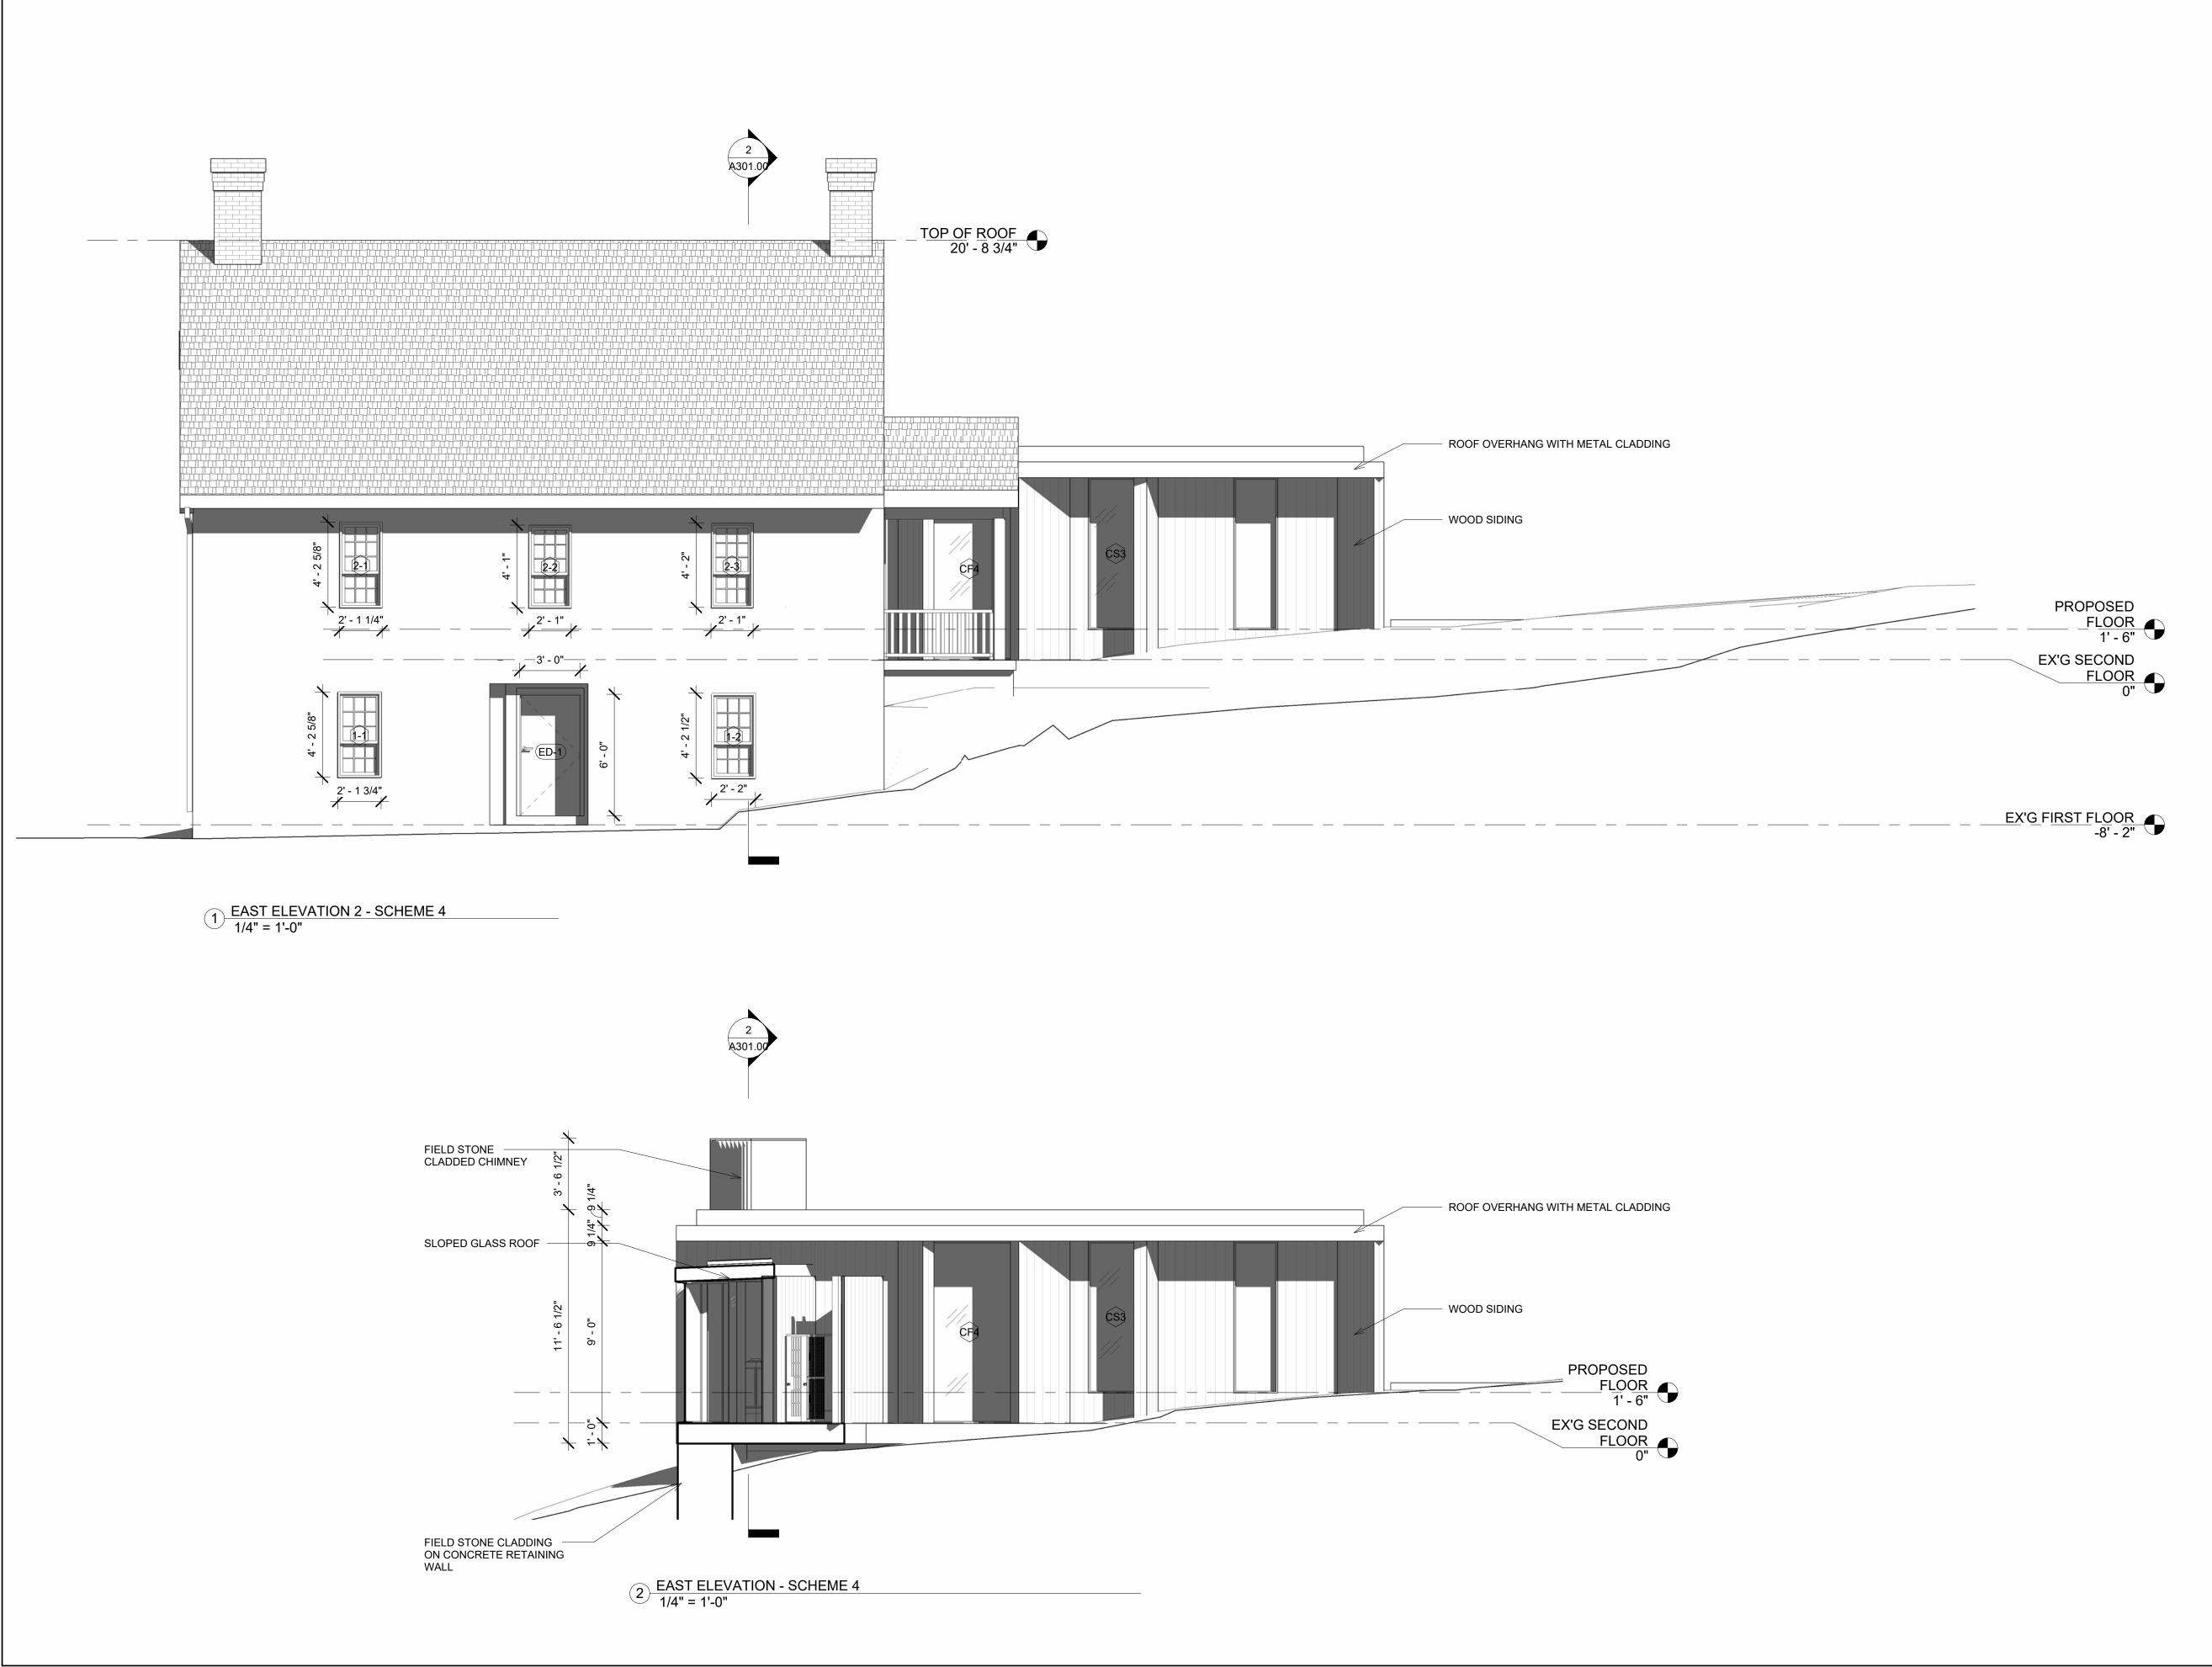
DATE	REVISION
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PROJECT



FLOOR- AND ROOFPLANS Copy 1

ZONING DISTRICT	000	BLOCK	000
ZONING MAP	000	LOT	000
SEAL & SIGNATUR		DATE	05/14/2024
		JOB NO .:	0141
		SCALE:	1/4" = 1'-0"
		DRAWING NO .:	
		A10	3.00



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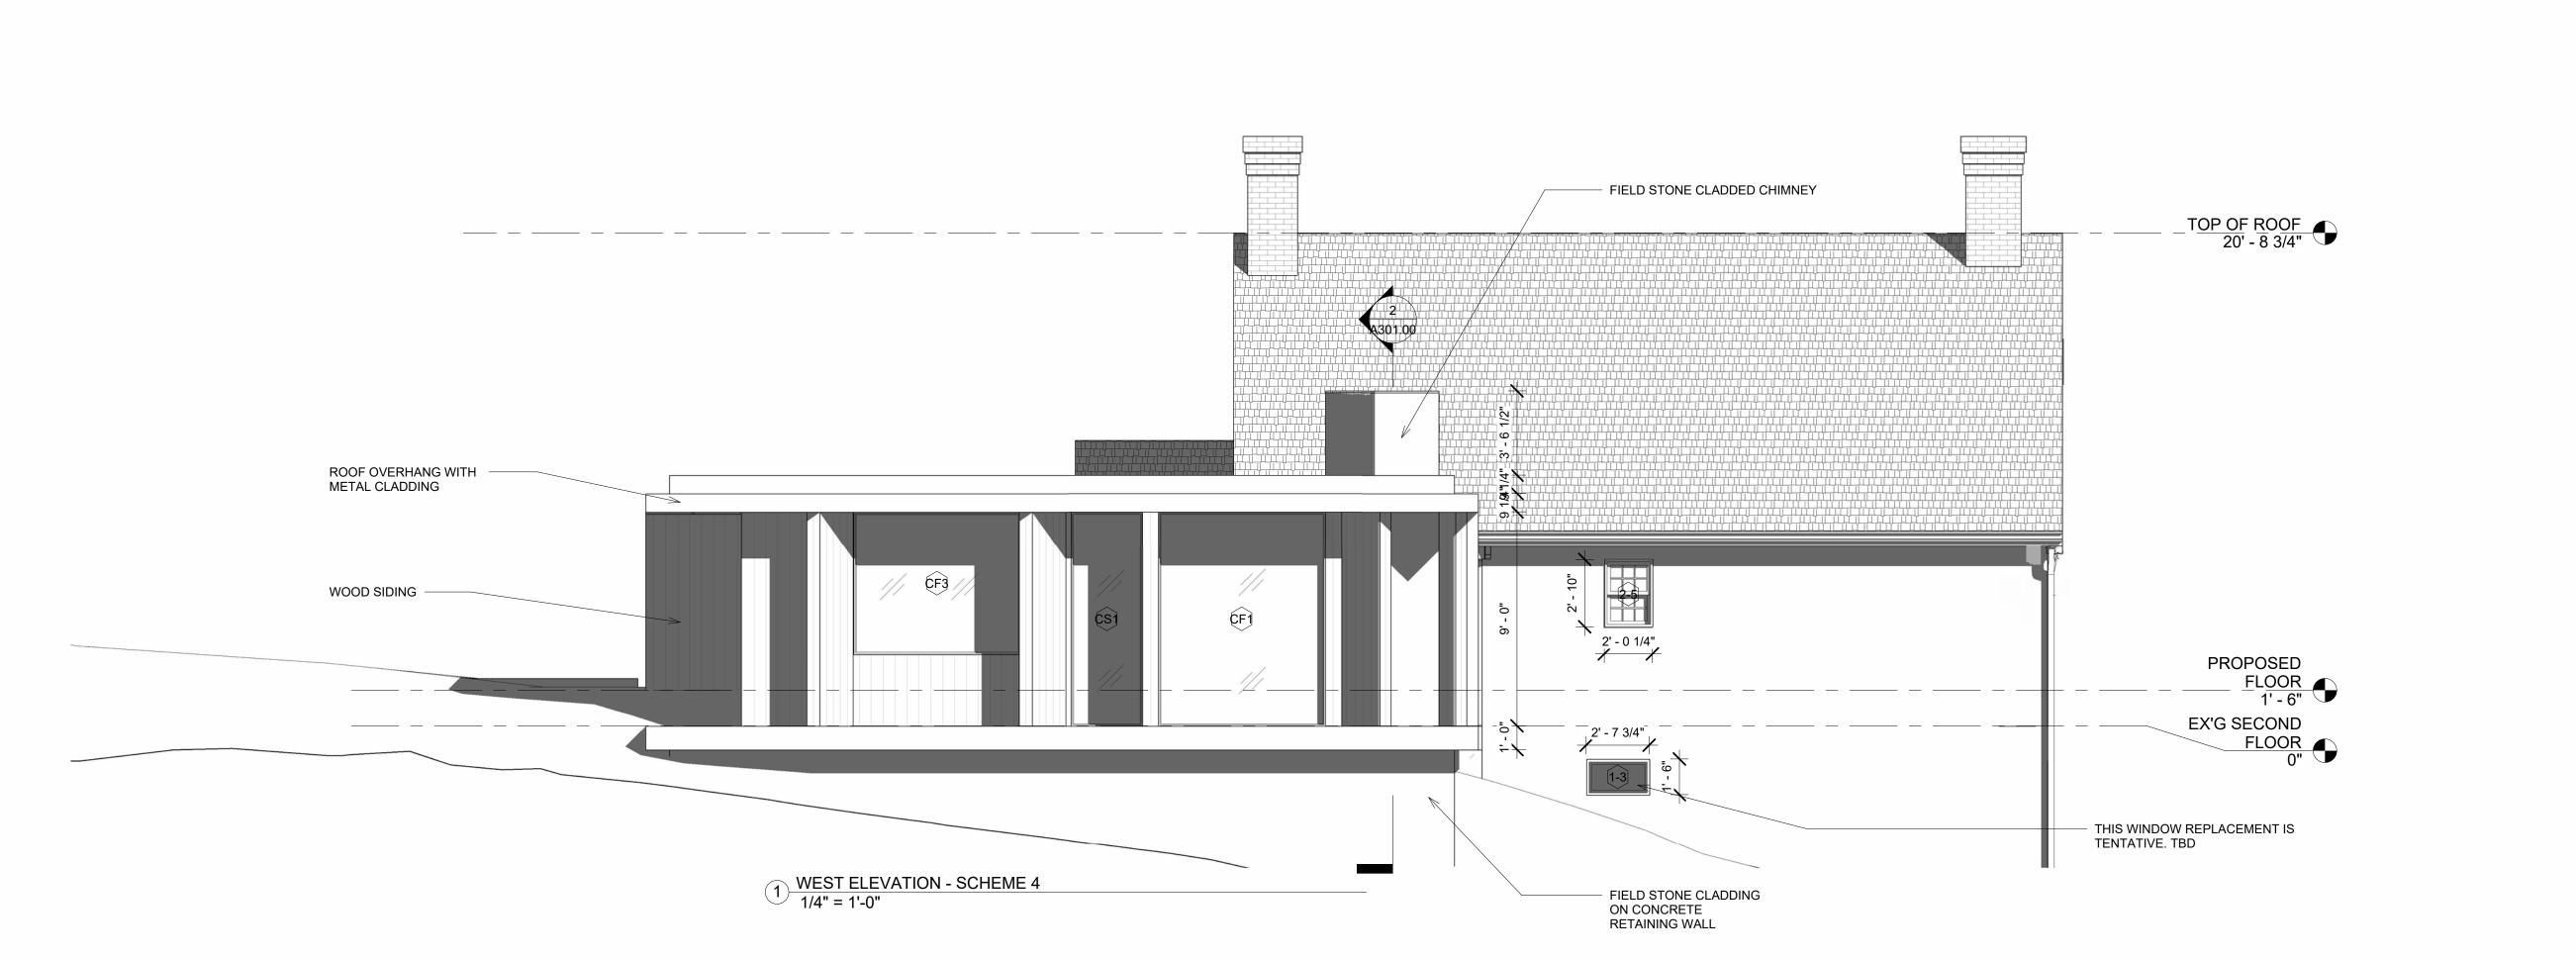
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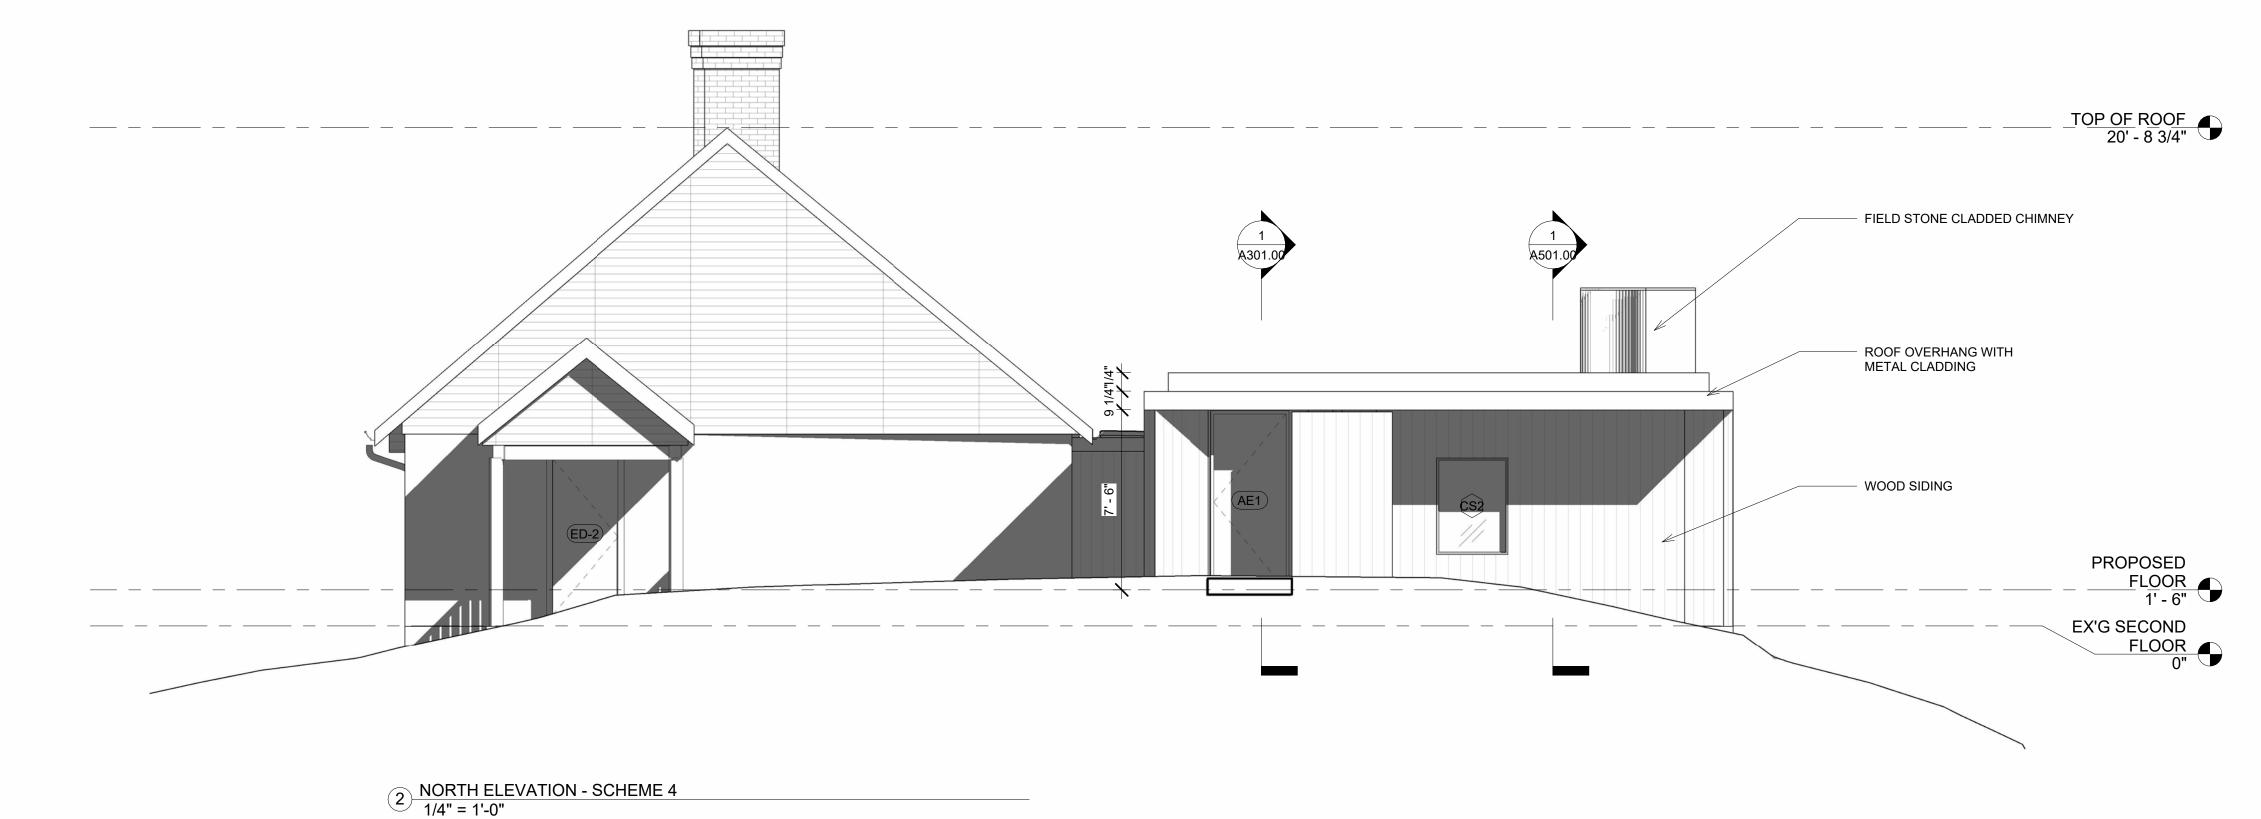
PROJECT

### 264 TACONIC RD. SALISBURY, CT 06068

## TITLE BUILDING ELEVATIONS -FRONT & REAR

ZONING DISTRICT	000	BLOCK	000
ZONING MAP	000	LOT	000
SEAL & SIGNATURE	=	DATE	05/14/2024
		JOB NO.:	0141
		SCALE:	1/4" = 1'-0"
		DRAWING NO .:	
		A20 <sup>-</sup>	1.00





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Structural Engineer Structural Engineer Name and Address

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DOB EXAMINER - SEAL & SIGNATURE


DATE	REVISION

PROJECT

## 264 TACONIC RD. SALISBURY, CT 06068

## TITLE BUILDING ELEVATIONS -SIDES

ZONING DISTRICT	000	BLOCK	000
ZONING MAP	000	LOT	000
SEAL & SIGNATUR	Ξ	DATE	05/14/2024
		JOB NO .:	0141
		SCALE:	1/4" = 1'-0"
		DRAWING NO .:	
		A202	2.00

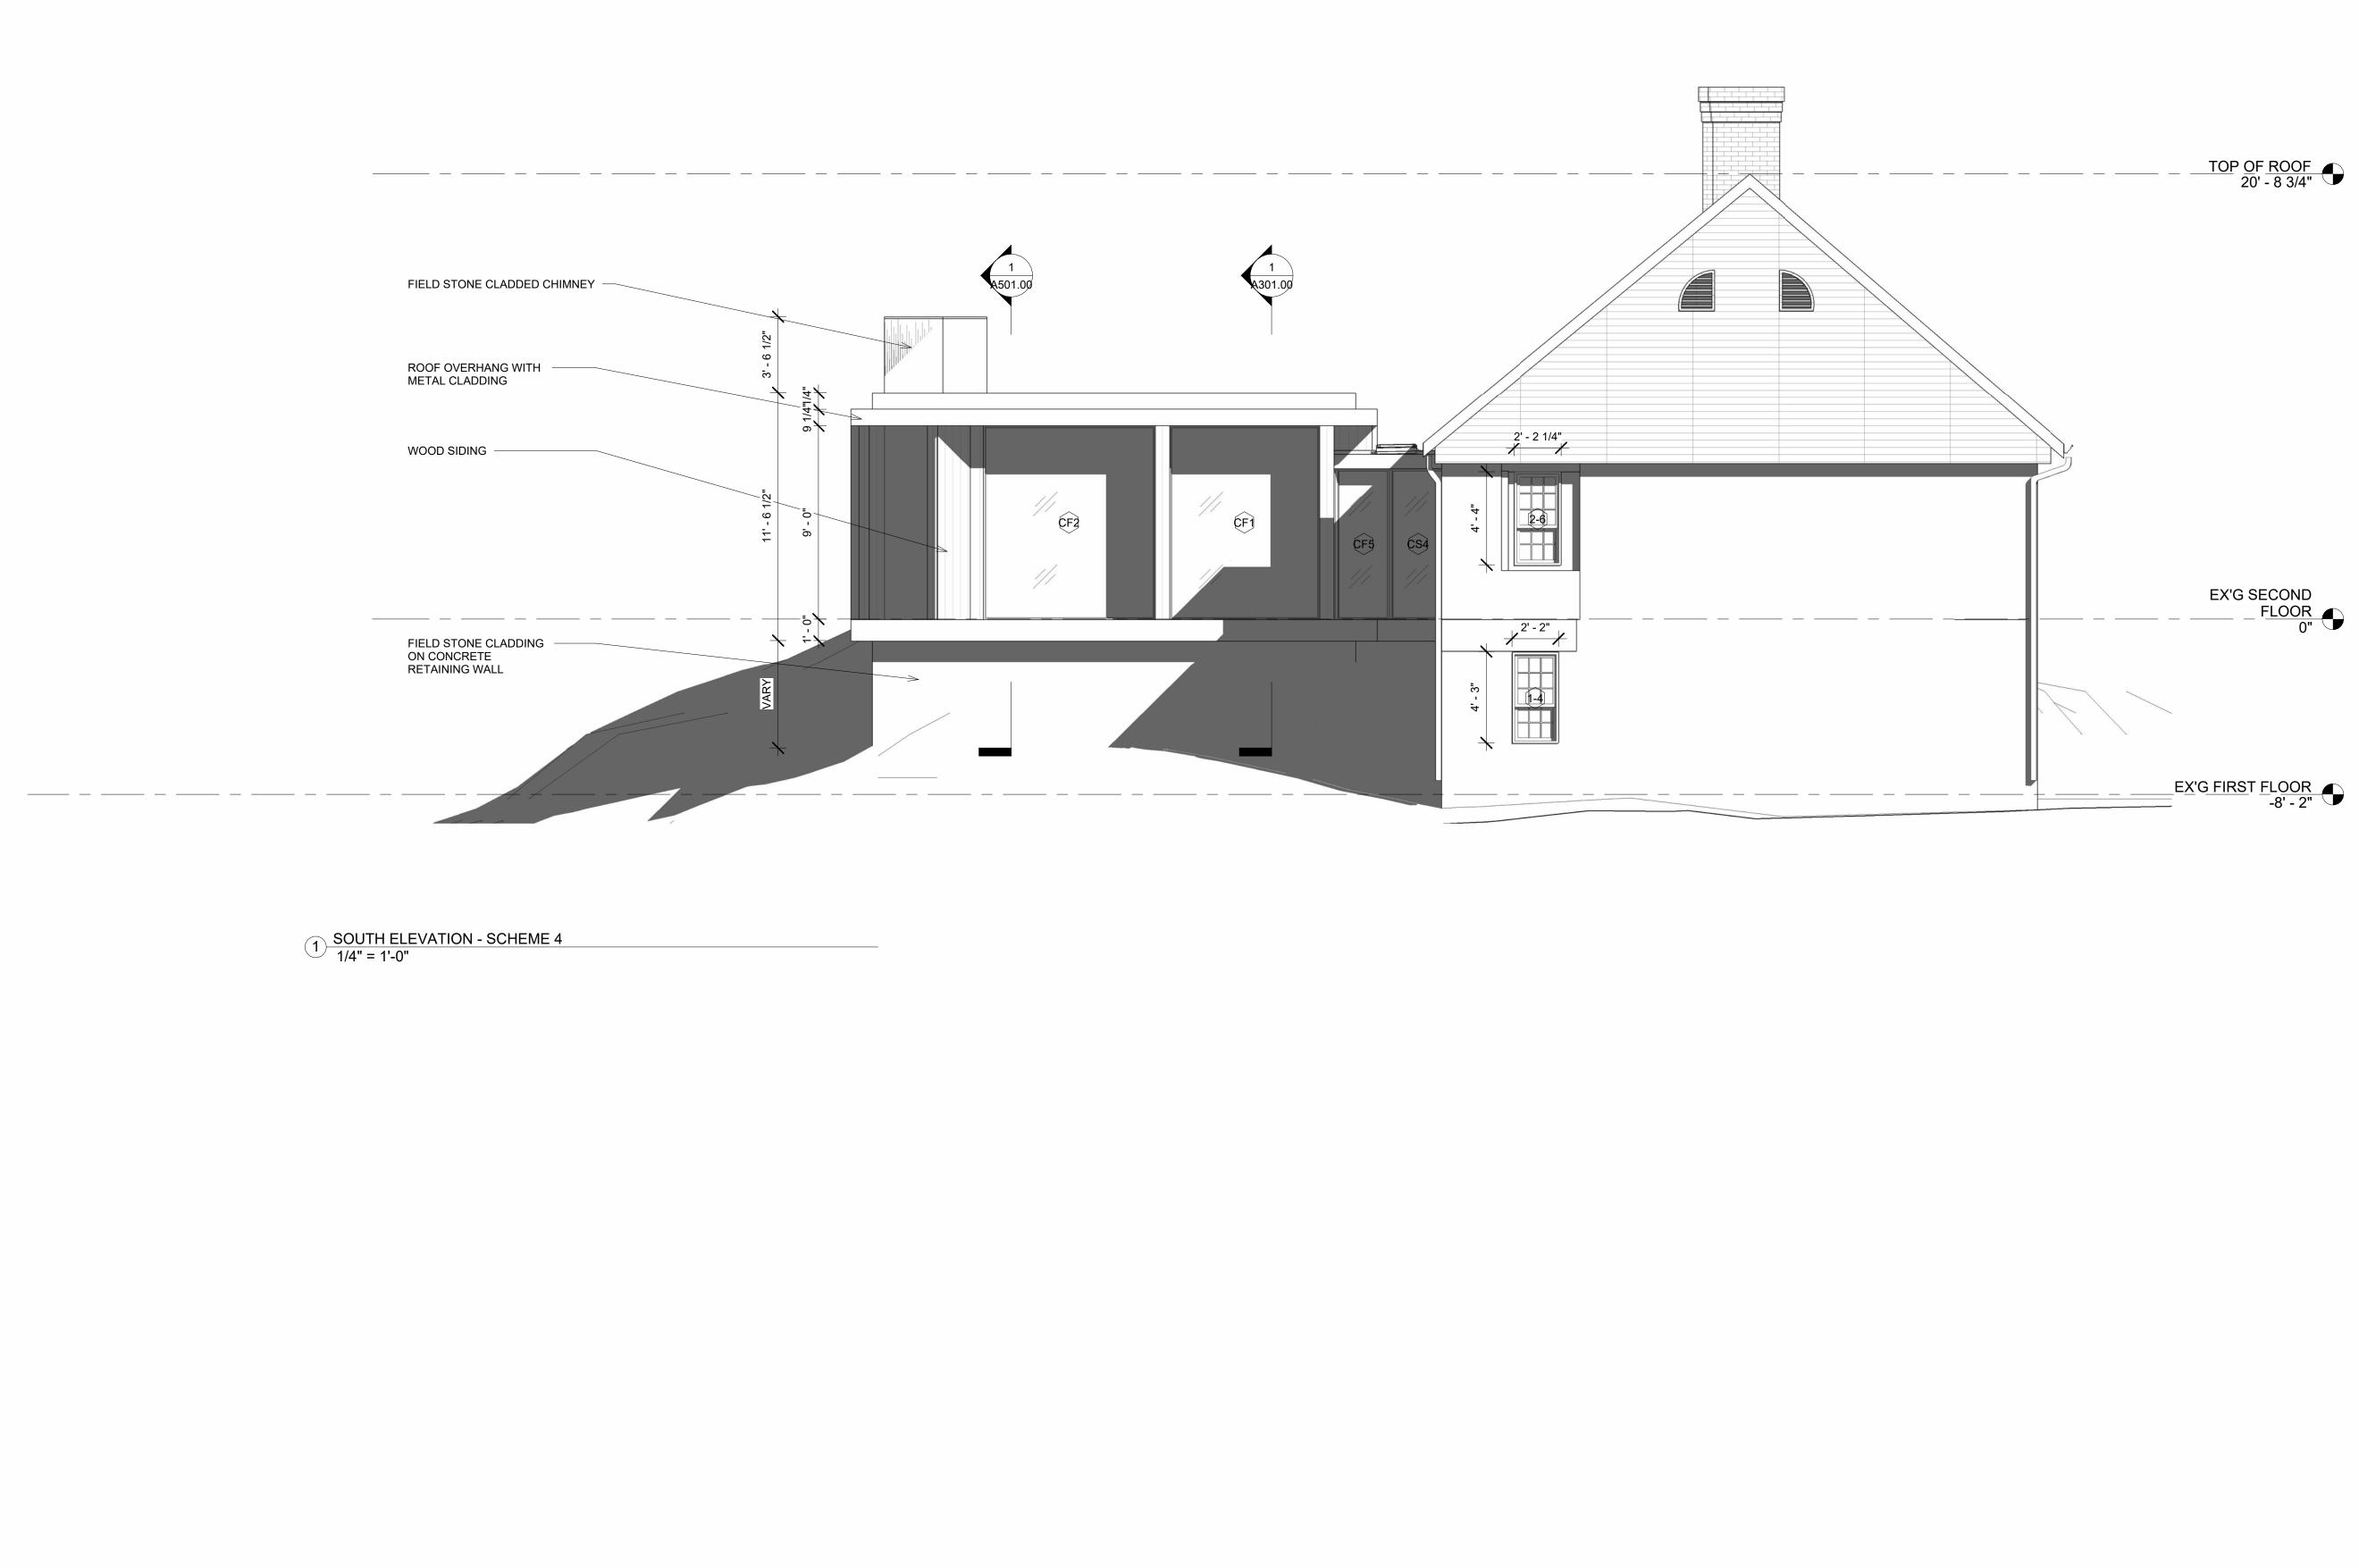

264 TACONIC RD. SALISBURY, CT 06068

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DOB EXAMINER - SEAL & SIGNATURE

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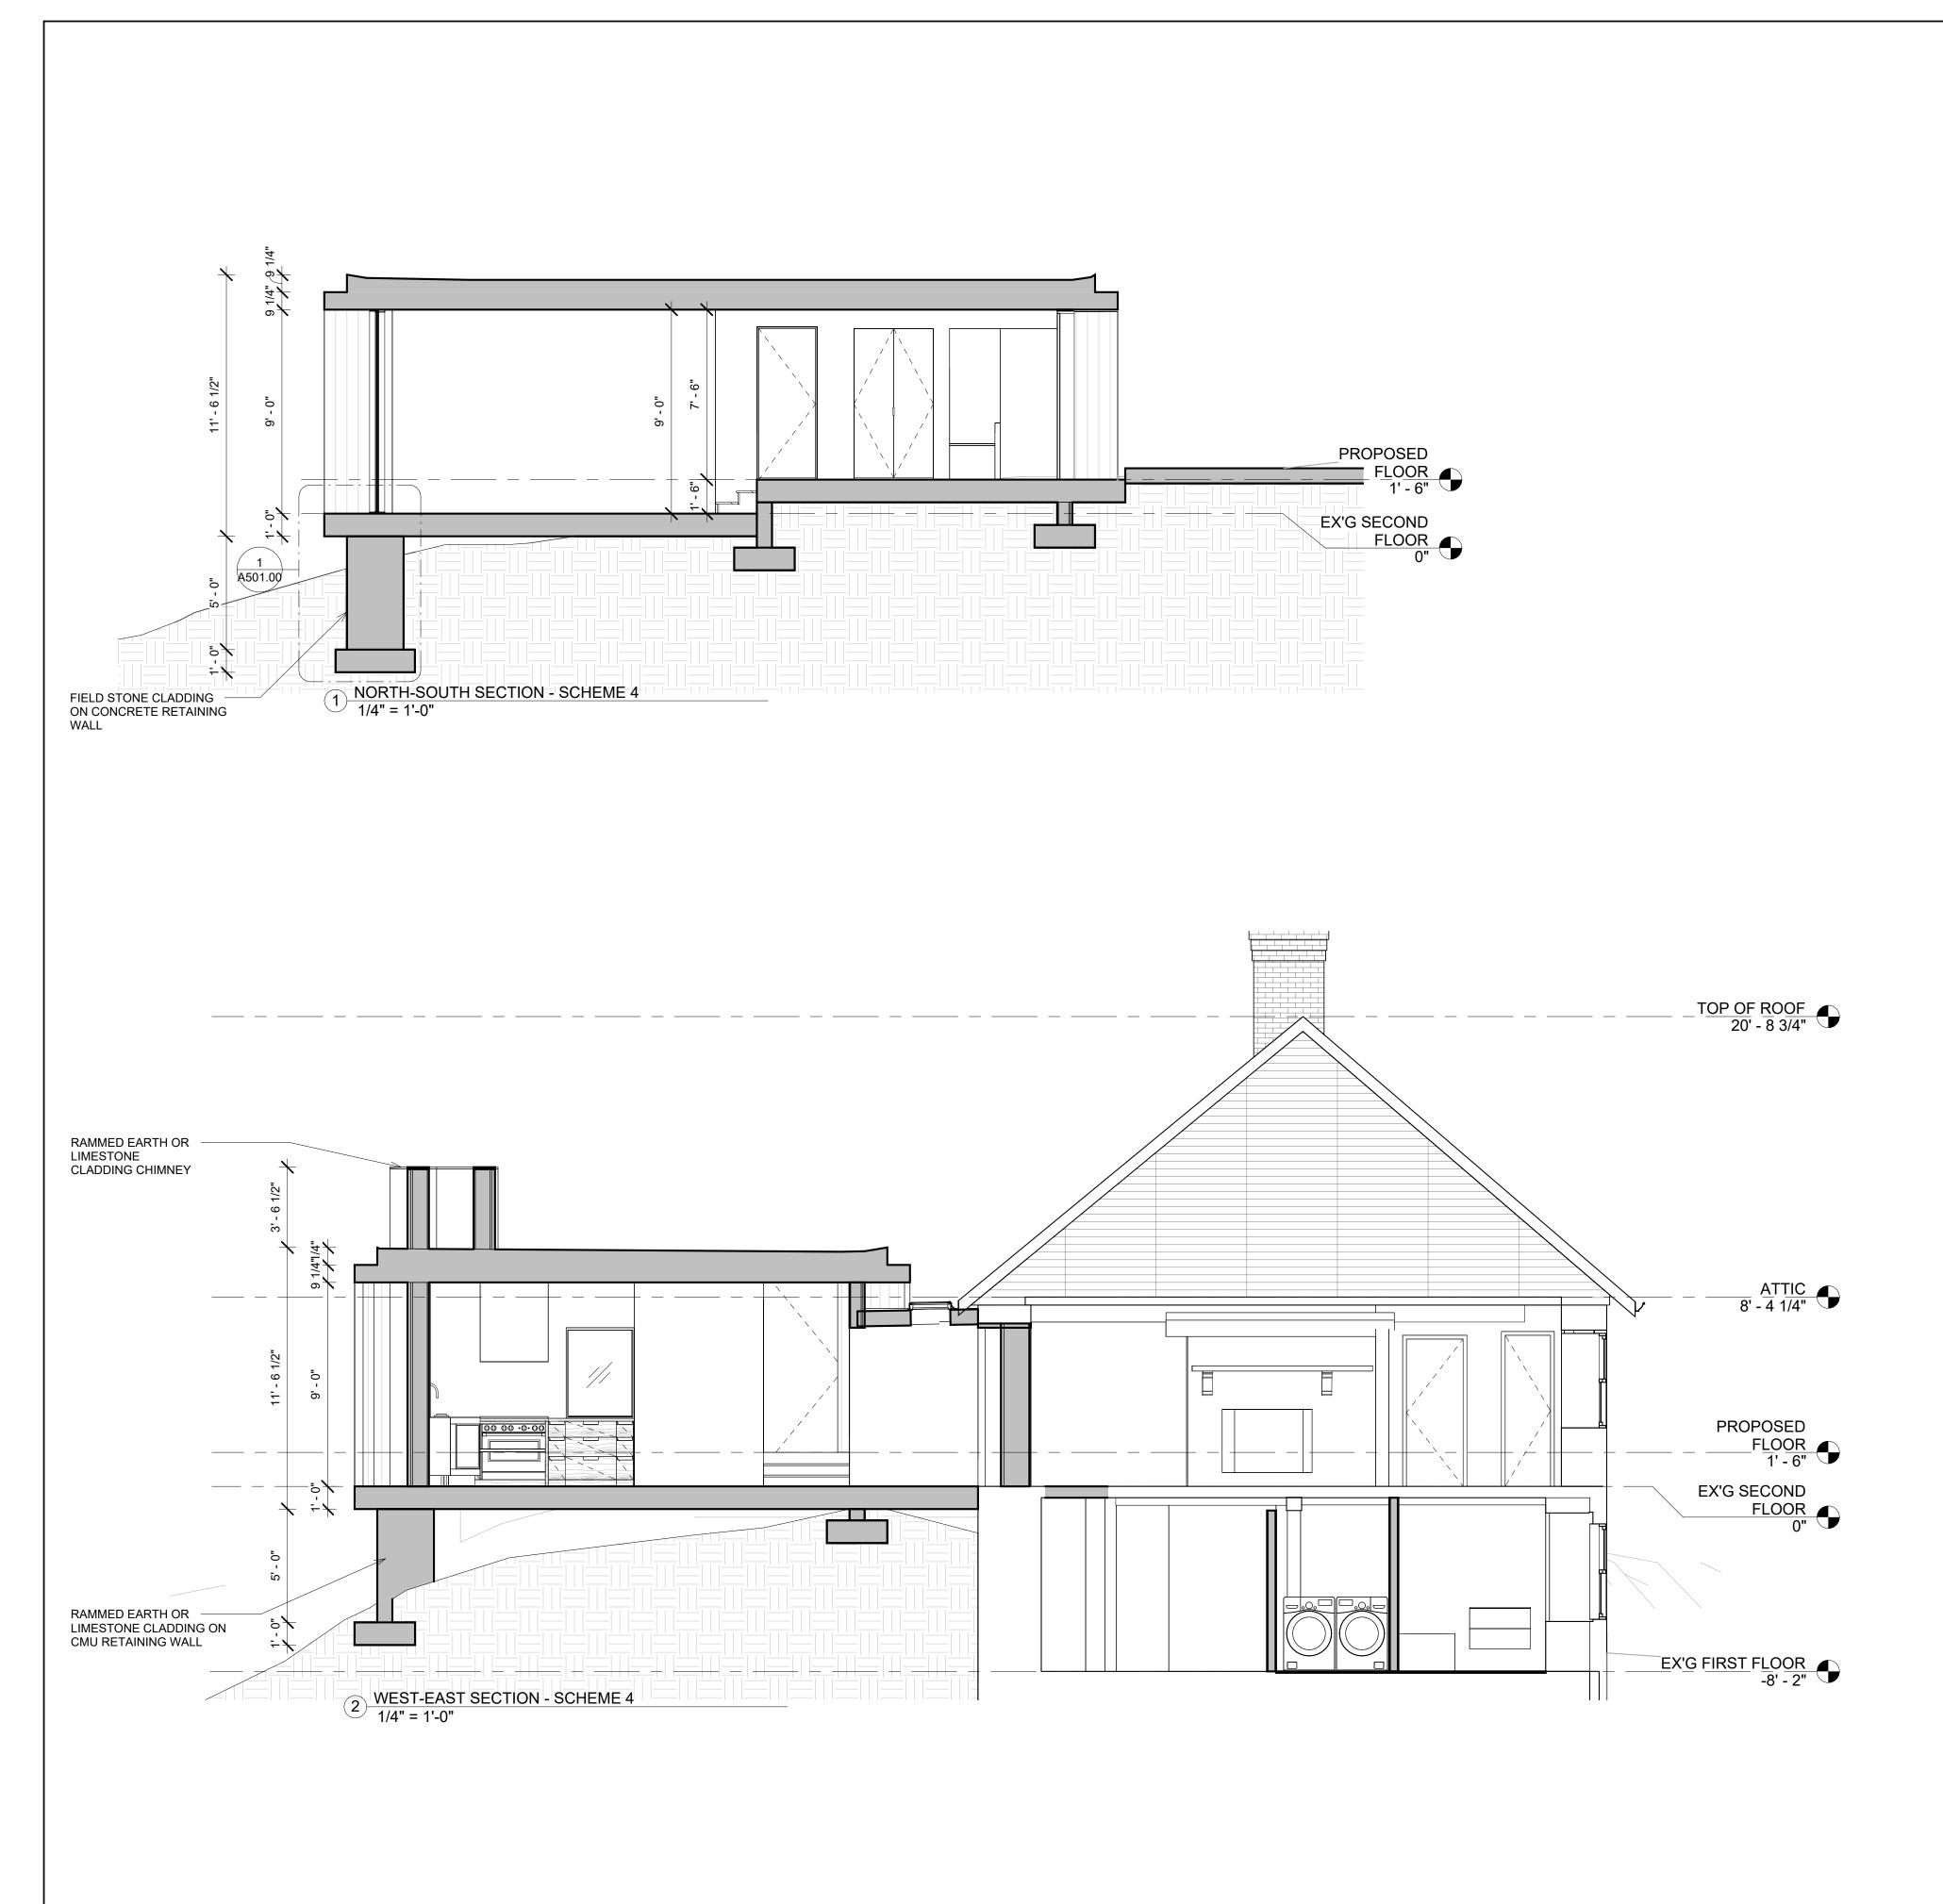
PROJECT

# 264 TACONIC RD. SALISBURY, CT 06068

## TITLE BUILDING ELEVATIONS -SIDES

ZONING DISTRICT	000	BLOCK	000
ZONING MAP	000	LOT	000
SEAL & SIGNATURE		DATE	05/14/2024
		JOB NO.:	0141
		SCALE:	1/4" = 1'-0"
		DRAWING NO .:	
		A20	3.00





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DATE	REVISION


PROJECT

TITLE

## 264 TACONIC RD. SALISBURY, CT 06068

### **BUILDING SECTIONS**

ZONING DISTRICT	000	BLOCK	000
ZONING MAP	000	LOT	000
SEAL & SIGNATURE	-	DATE	05/14/2024
		JOB NO .:	0141
		SCALE:	1/4" = 1'-0"
		DRAWING NO .:	
		A30	1.00

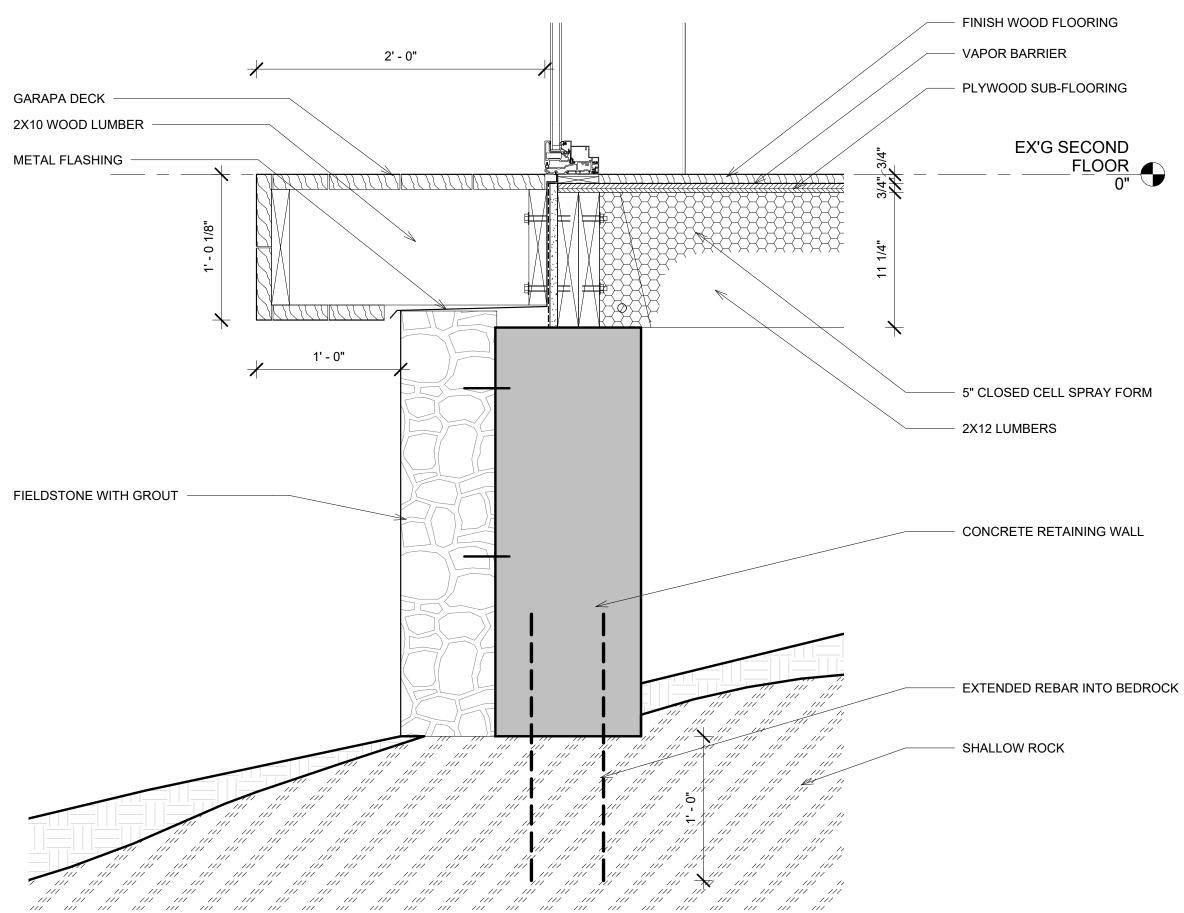

1 SECTION DETAIL - PLINTH 1 1/2" = 1'-0"

## 264 TACONIC RD.

264 TACONIC RD. SALISBURY, CT 06068

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Structural Engineer Structural Engineer Name and Address

### PROGRESS SET 05/14/2024

DOB EXAMINER - SEAL & SIGNATURE

DATE	REVISION

PROJECT



#### TITLE

## CONSTRUCTION DETAILS

ZONING DISTRICT	000	BLOCK	000
ZONING MAP	000	LOT	000
SEAL & SIGNATURE		DATE	05/14/2024
		JOB NO.:	0141
		SCALE:	1 1/2" =
		DRAWING NO .:	1'-0"
		A50 <sup>-</sup>	1.00

		WIND	OW SCHE	EDULE (SE	E EXTERIO	R ELEVAT	IONS FOR	TAGS)	
MARK	COUNT T	YPE WIDTH	HEIGHT SILL HEIGHT	DESCRIP				/	SHGC U
CF1 CF2	2 CASEMENT F 1 CASEMENT F		9' - 0" 0" 9' - 0" 0"	LIVING & DINING IN ADDI LIVING IN ADDITION	TION 63 SF 72 SF	0 SF ALUM. PTD 0 SF ALUM. PTD		ated - Low E3- Argon 0.1 ated - Low E3- Argon 0.1	
CF3 CF4	1 CASEMENT F 1 CASEMENT F	IXED 7' - 0"	6' - 0" 3' - 0" 9' - 0" 0"	KITCHEN IN ADDITION DINING IN ADDITION	42 SF 47 SF	0 SF ALUM. PTD 0 SF ALUM. PTD	ALUM. PTD Insula	ated - Low E3- Argon 0.1 ated - Low E3- Argon 0.1	9 0.2
CF5	1 CASEMENT F	IXED 2' - 9"	7' - 0" 0"	HALLWAY OPERABLE IN	ADDITION 19 SF	0 SF ALUM. PTD	ALUM. PTD Insula	ated - Low E3- Argon 0.1	9 0.1
CS1 CS2	1CASEMENT S1CASEMENT S	WING-IN 3' - 0"	9' - 0" 0" 4' - 0" 3' - 0"	LIVING OPERABLE IN AD KITCHEN OPERABLE IN A	DDITION 12 SF	27 SF         ALUM. PTD           12 SF         ALUM. PTD	ALUM. PTD Insula	ated - Low E3- Argon0.1ated - Low E3- Argon0.1	9 0.1
CS3 CS4	1 CASEMENT S 1 CASEMENT S		7' - 6" 1' - 6" 7' - 0" 0"	HALLWAY OPERABLE IN HALLWAY OPERABLE IN		21 SF ALUM. PTD 19 SF ALUM. PTD		ated - Low E3- Argon 0.1 ated - Low E3- Argon 0.1	
CS5	1 CASEMENT S		7' - 6" 1' - 6"	HALLWAY OPERABLE IN		21 SF ALUM. PTD		ated - Low E3- Argon 0.1	
MARK 1-1 1-2 1-3 1-4 2-1 2-2 2-3 2-5		H       UNIT TYPE: CASEM         EXTERIOR FINISH:       INTERIOR FINISH:         INTERIOR TYPE:       NOT         HARDWARE TYPE:       NOT         HARDWARE COLOF       SCREEN COLOR:         SCREEN MESH TYP       JAMB DEPTH: TBD         COMMENTS:       EXTERIOR CASING    TYPE          WIDTH       EXTERIOR CASING    TYPE           WIDTH       EXTERIOR 2' - 1''    Type:          2' - 1''       2' - 1''	MARVIN SIGNATURE OF IENT FIXED PAINTED BLACK PAINTED BLACK ON: IGU, LOW E W/ARG NE NONE NE R: MATTE BLACK ONE PE: NONE AND SUBSILL - WOOD	ON GAS SIDING	TIONS PROVID LIGHT DOR FAMILY ROOM 8 SF DOR BATH 8 SF DOR FAMILY ROOM 3 SF DOR FAMILY ROOM 8 SF FLOOR BEDROOM 1 8 SF FLOOR LIVING 7 SF FLOOR LIVING 7 SF		YPE: CASEMENT SWING-I IOR FINISH: PAINTED BLAG OR FINISH: PAINTED BLAG INFORMATION: IGU, LOW R TYPE: NONE VARE TYPE: SASH LOCK, IN TYPE: ALUMINUM SCRE VARE COLOR: MATTE BLA IN COLOR: MATCHES FRA IN MESH TYPE: BETTERVID DEPTH: TBD ENTS: IOR CASING AND SUBSILI MATCH EX'G INSU MATCH EX'G INSU MATCH EX'G INSU MATCH EX'G INSU MATCH EX'G INSU	ATURE OR APPROVED EQUAL N ICK ICK ICK HANDLE EEN ICK IME COLOR JE SCREEN CLOTH L - WOOD SIDING	SHGC         U-           9         0.1           9         0.1           9         0.1           9         0.1           9         0.1           9         0.1           9         0.1           9         0.1           9         0.1           9         0.1           9         0.1           9         0.1           9         0.1           9         0.1
		SING HUNG WINDOW (EX'G R MANUFACTURER: MARVIN SI UNIT TYPE: SINGLE HUNG EXTERIOR FINISH: NON-CLAE SPECIES: DOUGLAS FIR INTERIOR FINISH: PRIMED GLASS INFORMATION: IGU, L DIVIDER TYPE: NONE HARDWARE TYPE: SASH LOC SCREEN TYPE: HALF ALUMIN HARDWARE COLOR: SATIN N SCREEN COLOR: MATCHES F SCREEN MESH TYPE: BETTEI JAMB DEPTH: 4 9/16" COMMENTS: EXTERIOR CASING AND SUBS	GNATURE OR APPROV (ALL WOOD) OW E W/ARGON GAS CK, SASH LIFT UM SCREEN ICKEL RAME COLOR RVUE SCREEN CLOTH						
					LLATION OF WINDOW	-		SE" AND "MILL HOUSE." GC S	HALL
		E "MILL HOUSE WINDO							
			, <b>.</b>	, <b></b>					
				FXTERI	OR DOOR S				
TYPE MARK	COUNT	TYPE	WIDTH		DESCRIPTION			ERIAL/ FINISH FRAME MATERIAL	SHGC U-
	OND FLOOR	E FIRST FLOOR ENTRY DOOI	R 3' - 0"	6' - 0" ENTR	Y DOOR @ STONE HOUSE 1S		WOOD	WOOD	
ED-2 PROPOSE	1 STONE HOUS	E SECOND FLOOR ENTRY DO			Y DOOR @ STONE HOUSE 2N		WOOD	WOOD	0.3
AE1	1 NEW ENTRY I	DOOR	3' - 0"	7' - 4" ENTR	Y DOOR @ ADDITION	20 SF	METAL DOOR	METAL	0.3
		<u>ENTRY DOOR:</u> WOOR OR METAL							

GENERAL CONTRACTOR SHALL PROVIDE PRICING FOR MATERIALS AND INSTALLATION OF EXTERIOR DOOR REPLACEMENTS AT "OLD STONE HOUSE" AND "MILL HOUSE." GC SHALL CONSULT WITH ARCHITECT AND OWNER ABOUT DOOR OPTIONS WITH RESPECT TO HISTORIC DISTRICT COMMISSION AND PRICING.

GC SHALL MEASURE "MILL HOUSE DOORS," FOR REPLACEMENT OPTIONS

#### FOR TAGS) INTERIOR DOOR SCHEDULE MARK TYPE MARK DOOR AIR THICKNE SHGC U-FACTOR WIDTH HEIGHT DESC. GLASS TYPE VISH LEAKAGE SS 0.28 EX'G FIRST FLOOR 0.19 Insulated - Low E3- Argon 0.06 Insulated - Low E3- Argon 0.19 0.28 0.06 1-1 83 SINGLE FLUSH DOOR 3' - 0" 7' - 0" 1 3/8" Insulated - Low E3- Argon 0.19 0.28 0.06 1-2 59 SINGLE FLUSH DOOR 2' - 8" 7' - 0" 1 3/8" 2' - 6" 7' - 0" 1 1/2" Insulated - Low E3- Argon 0.19 0.28 0.06 SINGLE FLUSH DOOR 1-3 265 SINGLE FLUSH DOOR 2' - 6" 7' - 0" 1 1/2" Insulated - Low E3- Argon 0.19 0.28 0.06 1-4 265 Insulated - Low E3- Argon 0.19 0.2 EX'G SECOND FLOOR 0.28 Insulated - Low E3- Argon 0.19 0.28 A-5 DD DOUBLE FLUSH DOOR 3' - 7" 7' - 0" 1 3/8" 0.2 3' - 7" 4' - 0" A-6 DD DOUBLE FLUSH DOOR 0.19 0.28 1" Insulated - Low E3- Argon 0.2 Insulated - Low E3- Argon 0.19 0.28 0.2 PROPOSED FLOOR Insulated - Low E3- Argon 0.28 A-1 SD SINGLE FLUSH DOOR 2' - 6" 6' - 8" 1 3/8" 0.19 0.2 A-2 DD DOUBLE FLUSH DOOR 3' - 6" 6' - 8" 1 3/8" A-3 DD DOUBLE FLUSH DOOR 2' - 10" 6' - 8" 1"

0.28

0.28

SHGC U-FACTOR AIK LEAKAGE

0.2 0.2

0.35

0.2

0.2

HARDWARE NOTE: LEVER: EMTEK STUTTGART LEVER W/ DISK ROSETTE IN FLAT BLACK HARDWARE SETS

A. PRIVACY LOCKSET : EMTEK STUTTGART LEVER W/ DISK ROSETTE **B. PASSAGE LOCKSET** : EMTEK STUTTGART LEVER W/ DISK ROSETTE C. DUMMY LOCKSET : EMTEK STUTTGART LEVER W/ DISK ROSETTE (ONE SIDE ONLY - NO LATCH -PR W/ ROLLER BALL CATCH)

- ALL NEW SLAB DOORS SHALL RECEIVE :SET TYPE A, B, C (SEE • SCHEDULE FOR SET TYPES) ALL FLUSH SLAB DOORS INSTALLED AS INVISIBLE DOORS TO
- RECEIVE CONCEALED HINGES; G.C. TO PROVIDE NUMBER OF AND SIZE OF HINGE PER MANUF. RECOMMENDATION PER DR HEIGHT & WEIGHT
- ALL FLUSH DOORS NOT INSTALLED AS INVISIBLE DOORS SHALL RECEIVE SQUARE BALL BEARING HINGES, THREE PER DOOR
- ALL LOCKSETS TO INCLUDE CORES GC WILL INSTALL DOORS STOPS AT ALL ROOM ENTRY DOORS
- (CLOSETS NOT INCLUDED)

#### GENERAL NOTES:


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- USE MILGO/BUFKIN "DSLR 025/050 SINGLE LEG REVEAL" GYP. BOARD BEAD FOR ALL FLUSH DOORS W/1/4" REVEAL. PAINT REVEAL SAME COLOR AS ADJACENT WALL THE FINISH FOR EACH DOOR HARDWARE SET - HINGES & LOCKSET -
- SHALL MATCH G.C. TO VERIFY FINISHED OPENINGS ON SITE & WITH DOOR
- MANUFACTURER ALL NEW HINGES TO BE COORDINATED WITH HEIGHT & WEIGHT OF
- DOORS; MIN. 2 /DR ALL DOORS TO BE 3/4" UNDERCUT
- ALL FLUSH WOOD DOORS TO BE SOLID CORE
- ALL NEW DOORS SHALL HAVE A 2 3/8" BACKSET









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- ALL REFURBISHED ORIGINAL DOORS TO BE SANDED AND PUTTIED -
- PREPPED FOR NEW FINISH
- GC TO CONFIRM BACKSET AT ALL REFURBISHED ORIGINAL DOORS

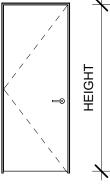

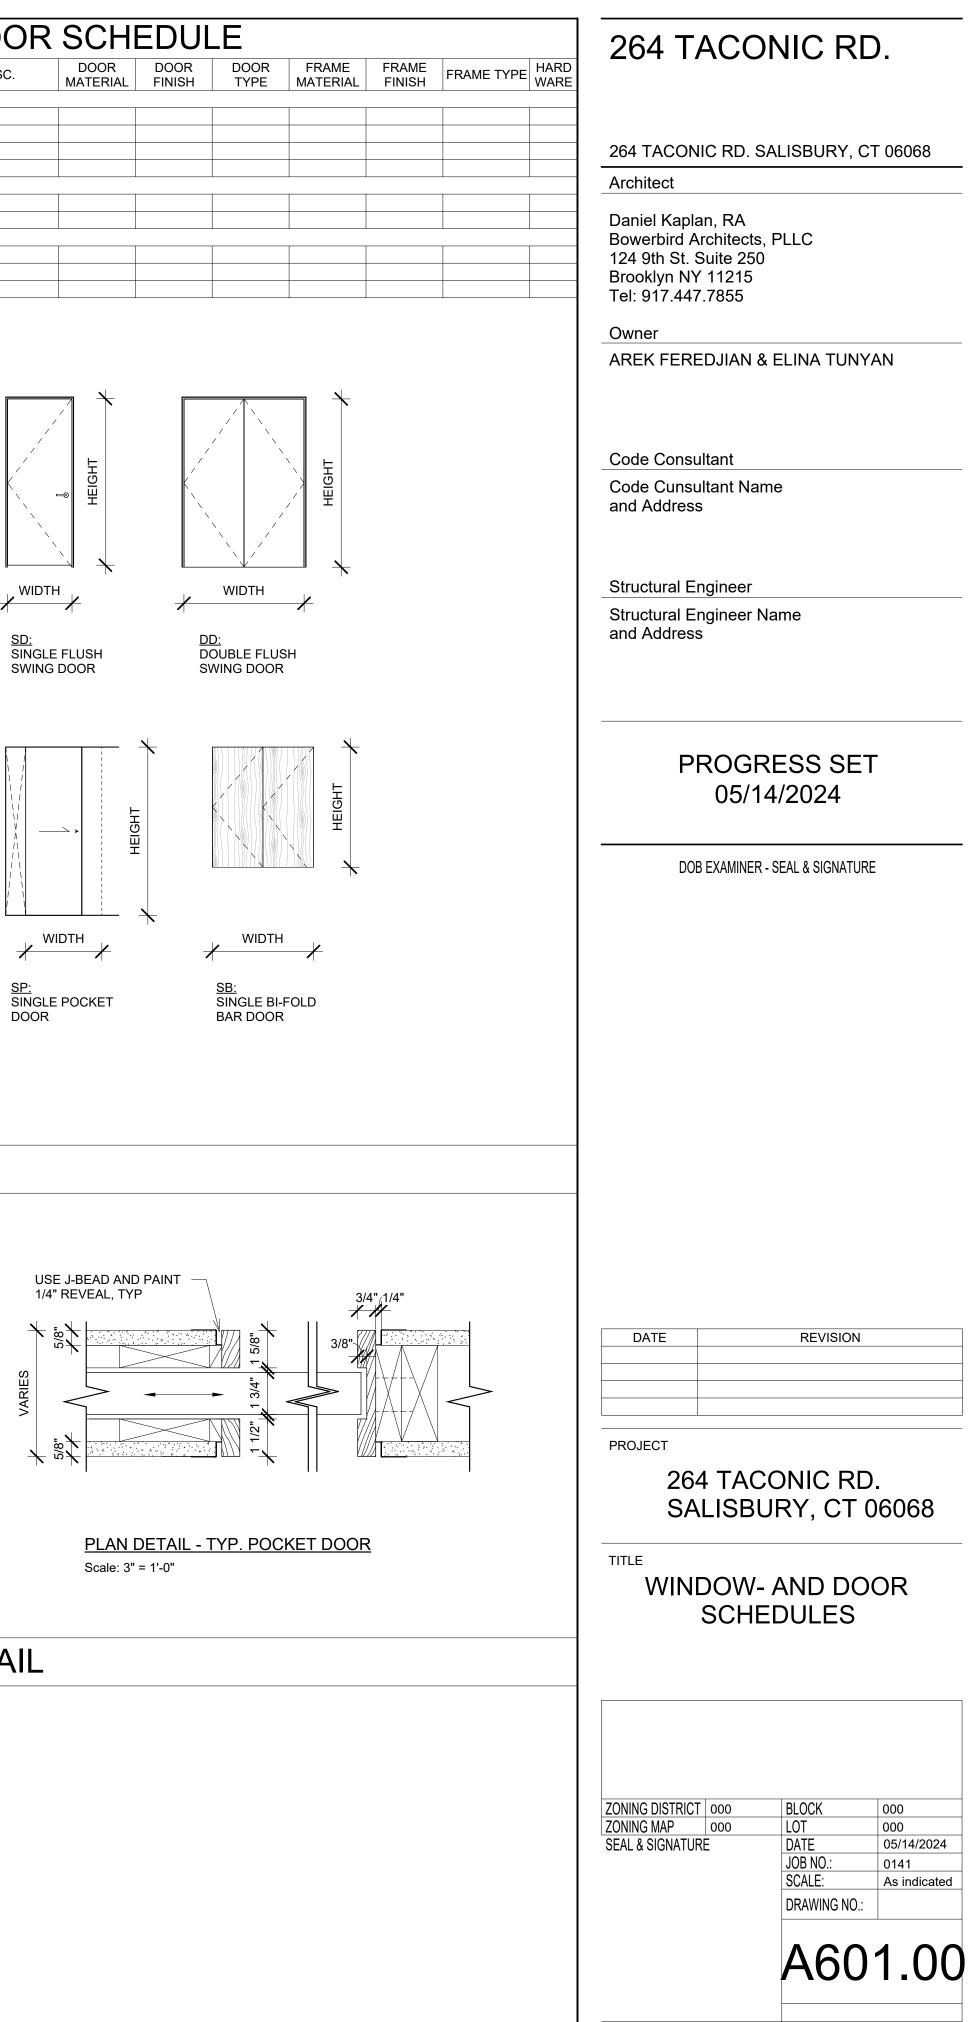
# DOOR

## **INTERIOR DOOR DETAILS**

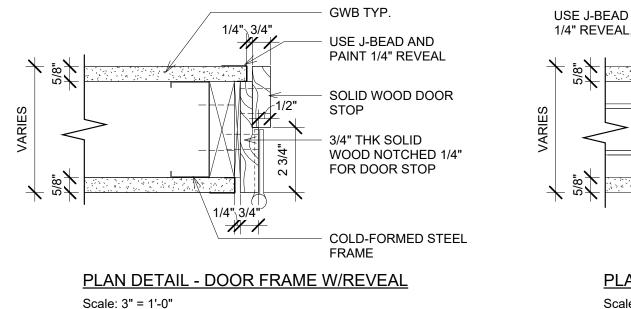


METAL 0.35 0.2



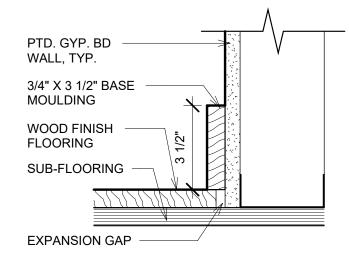

SECTION DETAIL - TYP. NEW BASE MOULDING Scale: 3" = 1'-0"

© BOWERBIRD ARCHITECTS 2022 - DO NOT SCALE FROM DRAWINGS

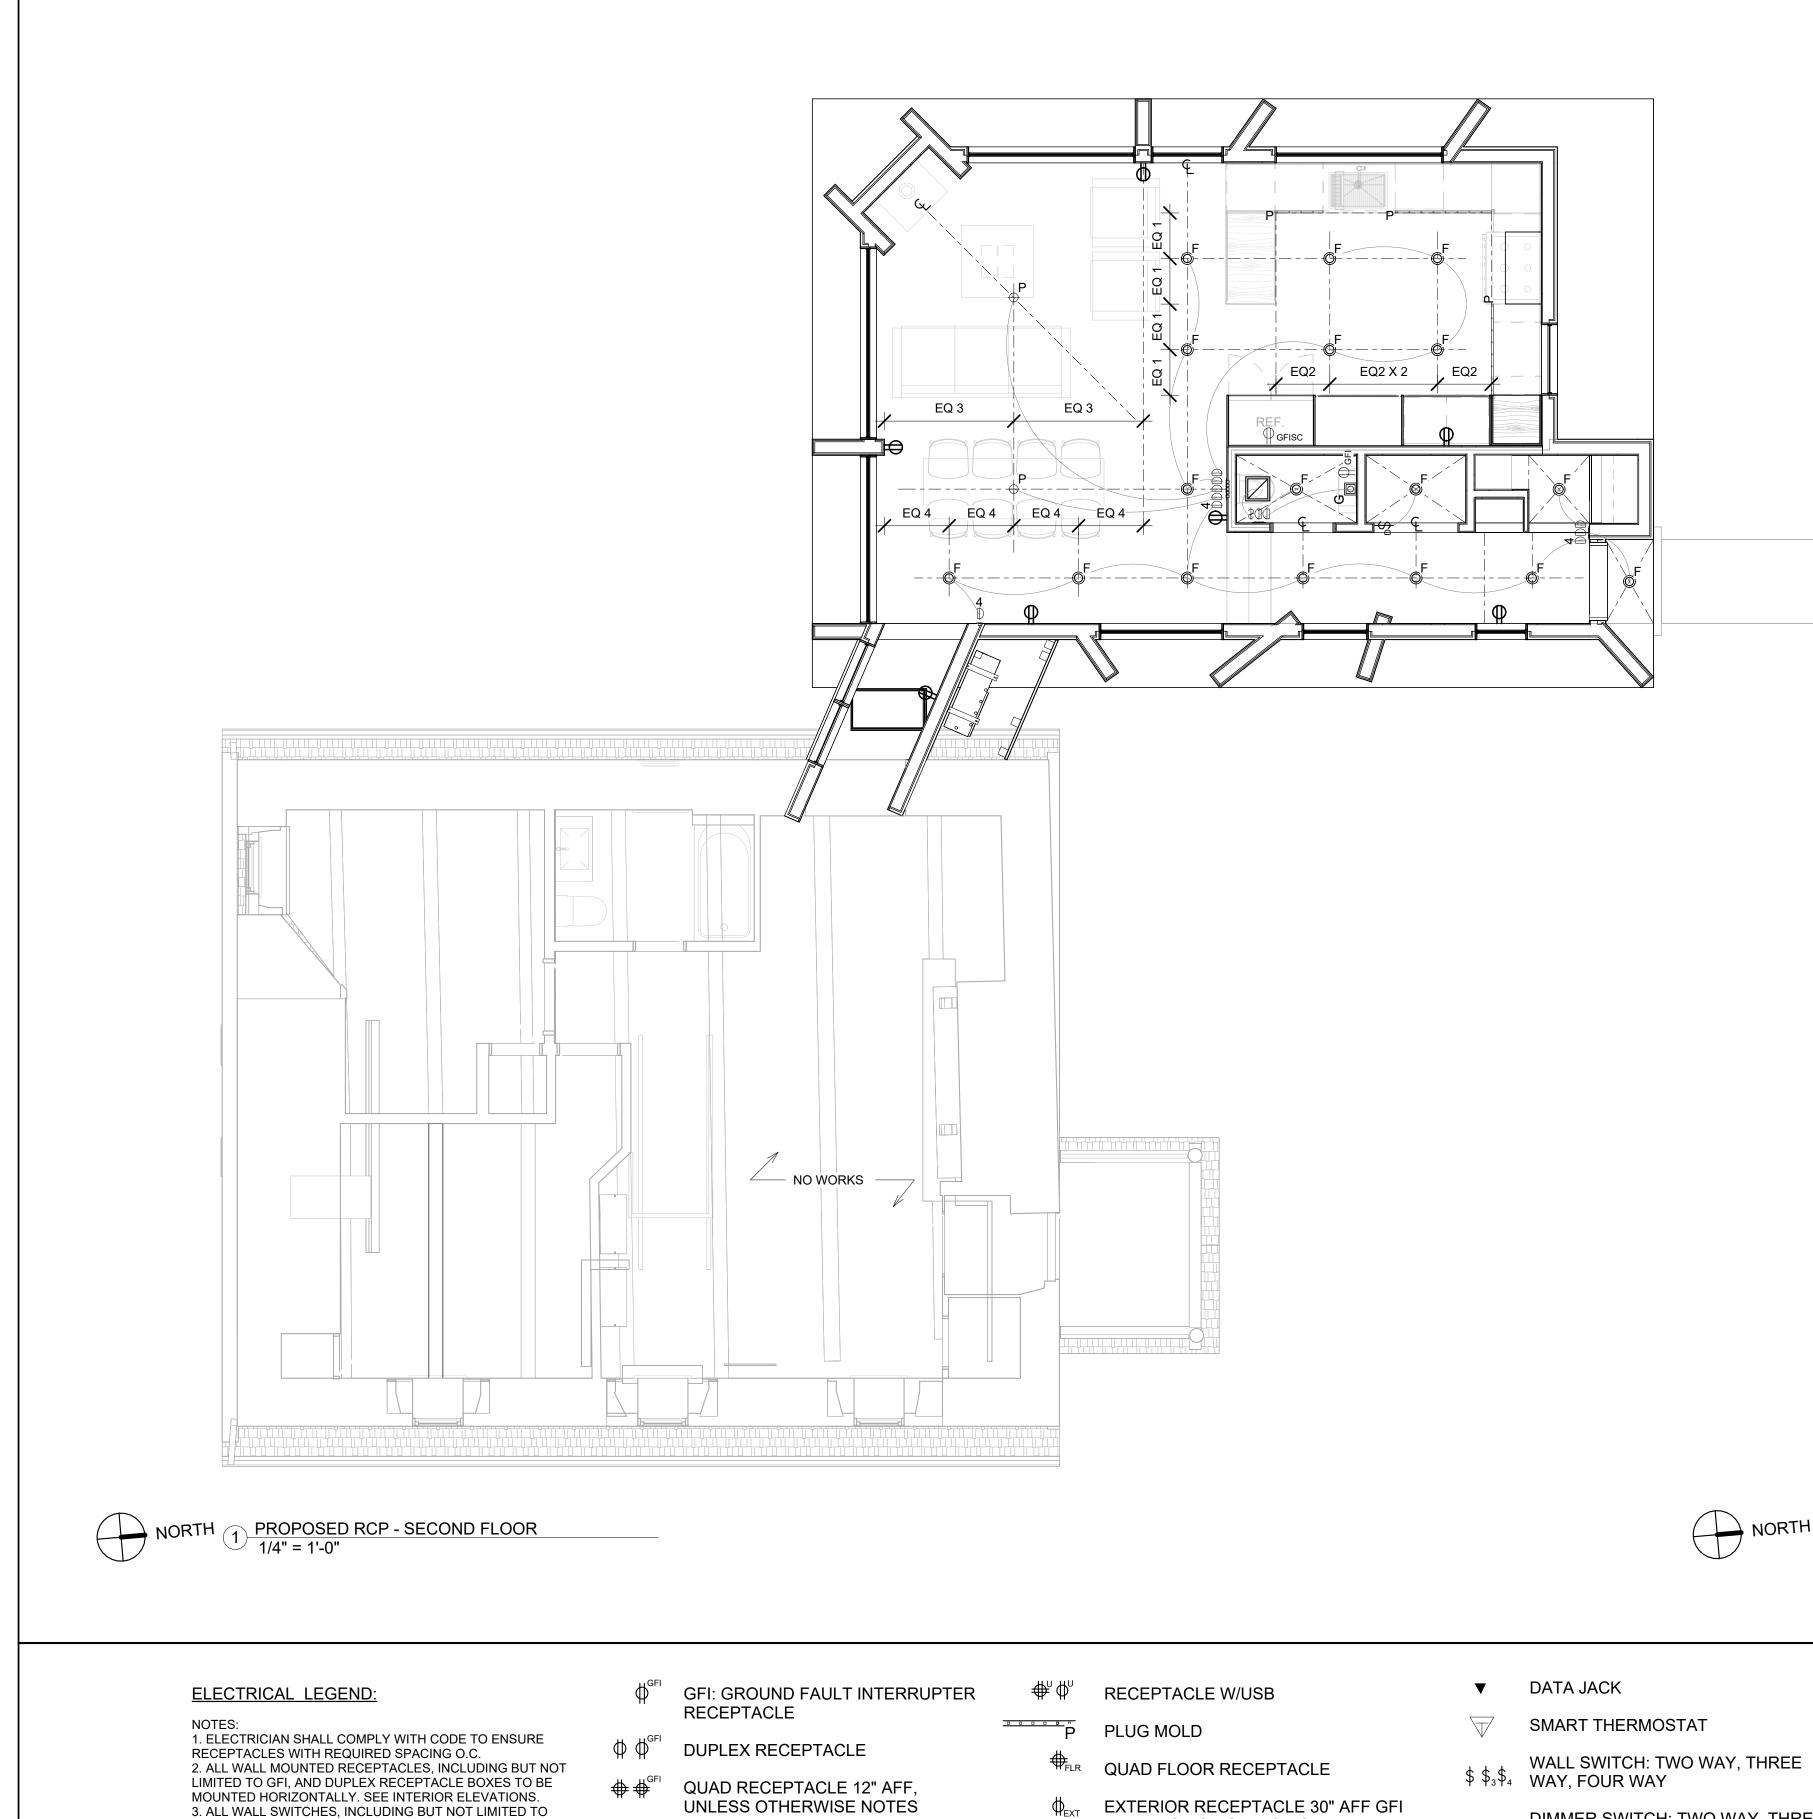


DIMMERS AND MULTI WAY SWITCHES TO BE MOUNTED

SEPARATE CIRCUIT

 $\oint_{FLR}$  FLOOR RECEPTACLE

VERTICALLY. SEE INTERIOR ELEVATIONS

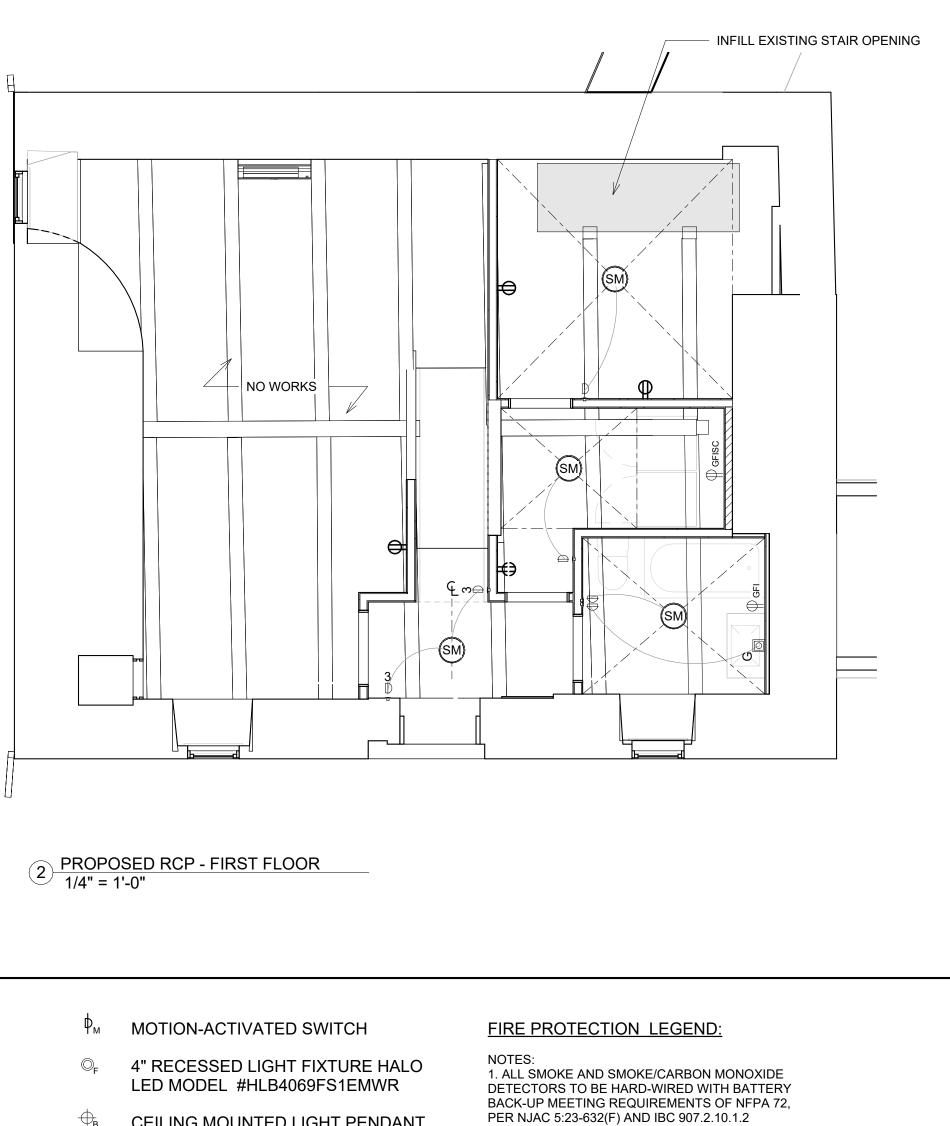

- IN WP BOX ON SEP. CIRCUIT
- ▼<sup>I.C.</sup> INTERCOM
  - CABLE JACK

 $\bigcirc$ 

- DIMMER SWITCH: TWO WAY, THREE  $\phi \phi_3 \phi_4 \quad \text{WAY, FOUR WAY}$ 
  - SWITCHED TO DOOR BUCK

- ← CEILING MOUNTED LIGHT PENDANT
- □<sub>G</sub> WALL MOUNTED LIGHT FIXTURE
- SM SURFACE MOUNTED LIGHT FIXTURE

6/C)

## 264 TACONIC RD.

264 TACONIC RD. SALISBURY, CT 06068

Architect

Daniel Kaplan, RA Bowerbird Architects, PLLC 124 9th St. Suite 250 Brooklyn NY 11215 Tel: 917.447.7855

Owner

AREK FEREDJIAN & ELINA TUNYAN

Code Consultant Code Cunsultant Name and Address

Structural Engineer Structural Engineer Name and Address

### PROGRESS SET 05/14/2024

DOB EXAMINER - SEAL & SIGNATURE

COMBINATION SMOKE & CARBON MONOXIDE DETECTOR (WALL MOUNTED ABOVE DOORS WHEREVER POSSIBLE, U.O.N.)

DATE	REVISION


PROJECT

TITLE

### 264 TACONIC RD. SALISBURY, CT 06068

## **RCP AND ELECTRICAL** PLANS

ZONING DISTRICT	000	BLOCK	000
ZONING MAP	000	LOT	000
SEAL & SIGNATURE		DATE	05/14/2024
		JOB NO.:	0141
		SCALE:	1/4" = 1'-0"
		DRAWING NO .:	
		E10 <sup>-</sup>	1.00

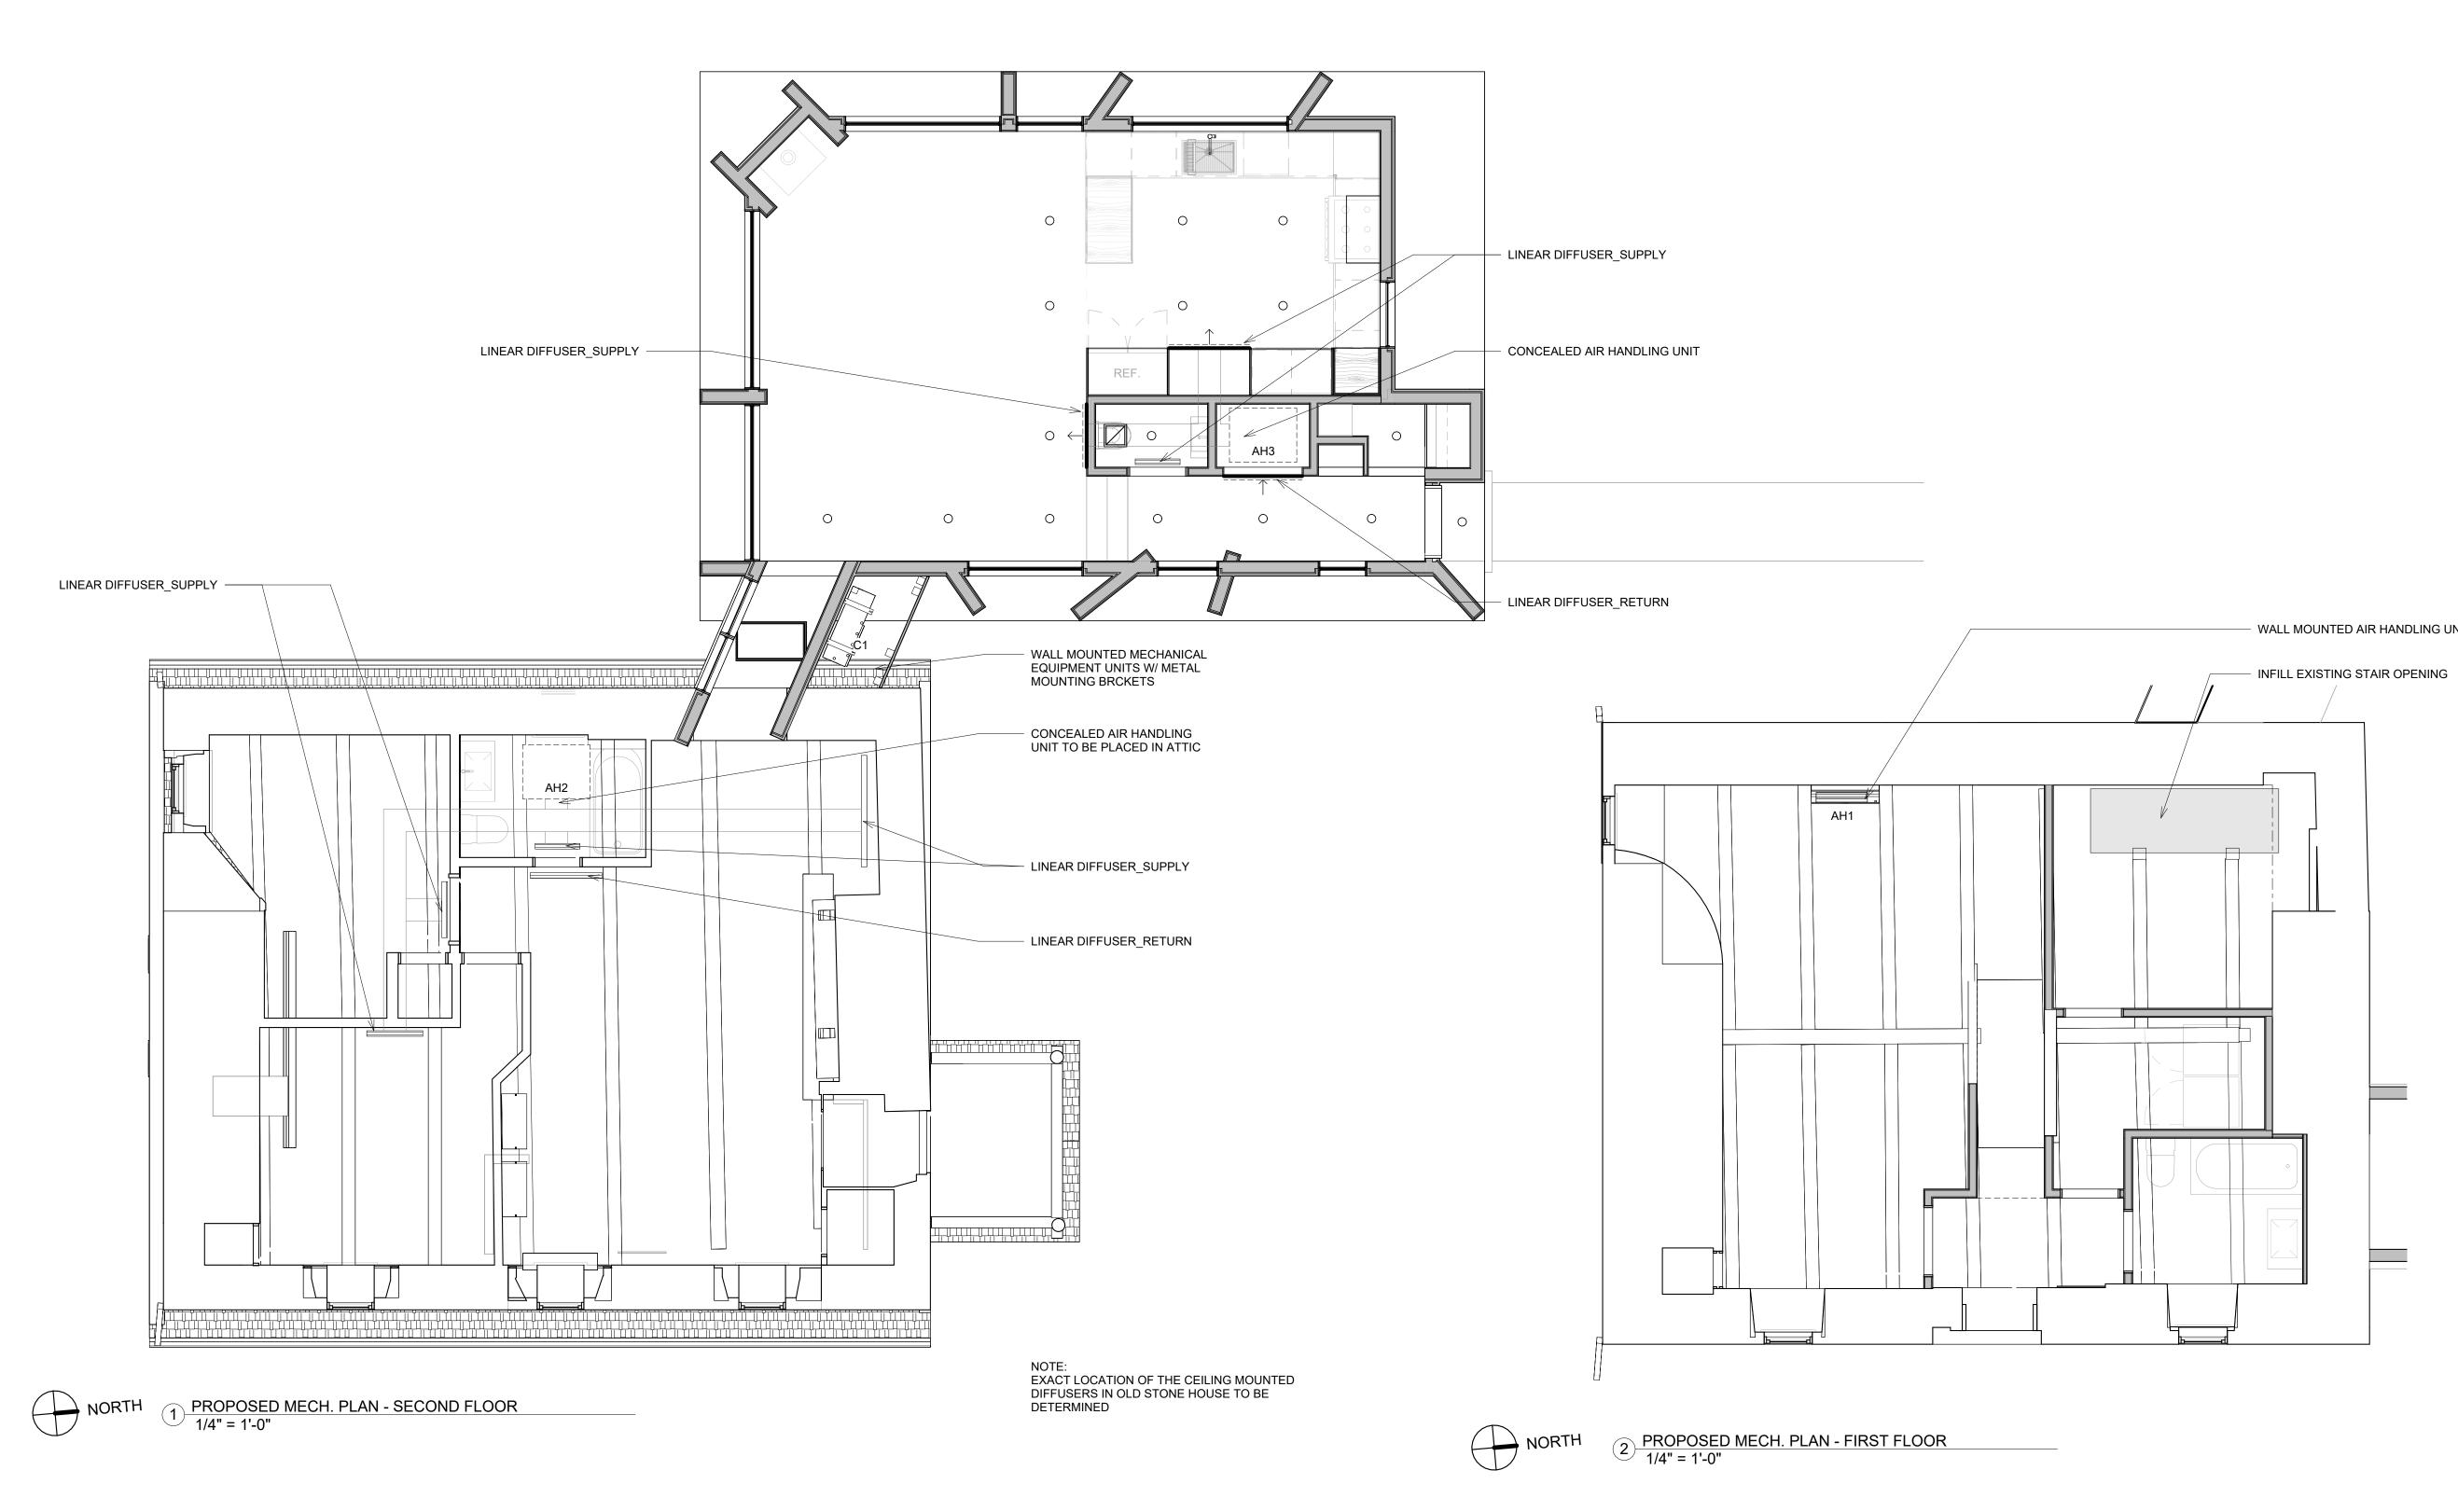

#### MECHANICAL SCHEDULE

MECHANICAL SCHEDULE									
ITEM	QTY	MANUFACTURER/MODEL	LOCATION	AREA SERVED	<u>BTU/H</u>	<u>SEER</u>	<u>HSPF</u>	W X L X H (INCHES)	<u>WEIGHT (LBS)</u>
CONDENSING UNIT	1	MITSUBISHI MXZ-SM48NAMHZ2	OUTDOOR	ADDITION	<u>48,000</u>	<u>23</u>	<u>12</u>	41 11/32" X 13" X 52 11/16"	278
AIR HANDLING UNIT -WM	1	MITSUBISHI MSZ-EF12NAW-U2	ADDITION	ADDITION	<u>12,000</u>	<u>N/A</u>	<u>N/A</u>	34 13/16" X 7 11/16" X 11 3/4"	26
AIR HANDLING UNIT	1	MITSUBISHI PEAD-A18AA9	ADDITION	ADDITION	<u>18,000</u>	<u>N/A</u>	<u>N/A</u>	35 7/16" X 28 7/8" X 9 7/8"	60
AIR HANDLING UNIT	1	MITSUBISHI PEAD-A18AA9	ADDITION	ADDITION	<u>18,000</u>	<u>N/A</u>	<u>N/A</u>	35 7/16" X 29 7/8" X 9 7/8"	60
	CONDENSING UNIT AIR HANDLING UNIT -WM AIR HANDLING UNIT	CONDENSING UNIT       1         AIR HANDLING UNIT -WM       1         AIR HANDLING UNIT       1	CONDENSING UNIT       1       MITSUBISHI MXZ-SM48NAMHZ2         AIR HANDLING UNIT -WM       1       MITSUBISHI MSZ-EF12NAW-U2         AIR HANDLING UNIT       1       MITSUBISHI PEAD-A18AA9	CONDENSING UNIT       1       MITSUBISHI MXZ-SM48NAMHZ2       OUTDOOR         AIR HANDLING UNIT -WM       1       MITSUBISHI MSZ-EF12NAW-U2       ADDITION         AIR HANDLING UNIT       1       MITSUBISHI PEAD-A18AA9       ADDITION	CONDENSING UNIT1MITSUBISHI MXZ-SM48NAMHZ2OUTDOORADDITIONAIR HANDLING UNIT -WM1MITSUBISHI MSZ-EF12NAW-U2ADDITIONADDITIONAIR HANDLING UNIT1MITSUBISHI PEAD-A18AA9ADDITIONADDITION	CONDENSING UNIT1MITSUBISHI MXZ-SM48NAMHZ2OUTDOORADDITION48,000AIR HANDLING UNIT -WM1MITSUBISHI MSZ-EF12NAW-U2ADDITIONADDITION12,000AIR HANDLING UNIT1MITSUBISHI PEAD-A18AA9ADDITIONADDITION18,000	CONDENSING UNIT1MITSUBISHI MXZ-SM48NAMHZ2OUTDOORADDITION48,00023AIR HANDLING UNIT -WM1MITSUBISHI MSZ-EF12NAW-U2ADDITIONADDITION12,000N/AAIR HANDLING UNIT1MITSUBISHI PEAD-A18AA9ADDITIONADDITION18,000N/A	CONDENSING UNIT1MITSUBISHI MXZ-SM48NAMHZ2OUTDOORADDITION48,0002312AIR HANDLING UNIT -WM1MITSUBISHI MSZ-EF12NAW-U2ADDITIONADDITION12,000N/AN/AAIR HANDLING UNIT1MITSUBISHI PEAD-A18AA9ADDITIONADDITION18,000N/AN/A	CONDENSING UNIT1MITSUBISHI MXZ-SM48NAMHZ2OUTDOORADDITION48,000231241 11/32" X 13" X 52 11/16"AIR HANDLING UNIT -WM1MITSUBISHI MSZ-EF12NAW-U2ADDITIONADDITION12,000N/AN/A34 13/16" X 7 11/16" X 11 3/4"AIR HANDLING UNIT1MITSUBISHI PEAD-A18AA9ADDITIONADDITION18,000N/AN/A35 7/16" X 28 7/8" X 9 7/8"

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Architect

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Owner

AREK FEREDJIAN & ELINA TUNYAN

Code Consultant Code Cunsultant Name and Address

Structural Engineer Structural Engineer Name and Address

## PROGRESS SET 05/14/2024

DOB EXAMINER - SEAL & SIGNATURE

DATE	REVISION

PROJECT

TITLE

## 264 TACONIC RD. SALISBURY, CT 06068

#### MECHANICAL PLANS

ZONING DISTRICT	000	BLOCK	000
ZONING MAP	000	LOT	000
SEAL & SIGNATURE	-	DATE	05/14/2024
		JOB NO.:	0141
		SCALE:	As indicated
		DRAWING NO.:	
		M10	1.00

WALL MOUNTED AIR HANDLING UNIT

























