(860) 435-5190 FAX: (860) 435-5172

Number



TOWN OF SALISBURY PLANNING AND ZONING COMMISSION

APPLICATION FOR SPECIAL PERMIT Owner of Record: PRISCILLA & ALAN MCCORD Address of Owner: 510 WEUS HILL RE, LAKEVILLE Property Location: Tax Map # Lot# Land Records: Vol. Page Property Address: 514 Wells HILL Rd, LAKEVILLE Acreage: Zone: Bounded generally on the North by: (Full name of owner of record. East by: Attach addition pages if needed) South by: SEE Affached UST) West by: Special Permit Use Requested: Carriage Barn Garage with Apartment Above Section of the Salisbury Zoning Regulations. Written statement of Proposed Use (4 copies): Attached Site Plan - 4 copies (See attached sheet) Soil Erosion and Sediment Control Plan. Approval from TAHD, WPCA, or BHC regarding sewer and water: Historic District Commission, if applicable: N/A Conservation District Commission, if applicable: NA Preliminary Architectural Plans for Proposed structures & signs (2 copies) Attached Estimated Site Improvement Costs (other than buildings): Written Assurance of Bond or Letter of Credit: Additional Remarks: resolo Date: 7.23.24 Owner's Signature: -Applicant's Signature and Title: Applicant's Address and phone number: , 20 Filed at the Planning and Zoning Commission Office this day of Fee Paid: Received By: Title:

NOTE: One copy of the written statement of proposed use SHALL be sent to all abutting landowners by certified mail. This is the responsibility of the owner/applicant. The signed return receipts shall be submitted with this application.

Michael Trapp, Inc.

7 River Road • Box 67 West Cornwall, CT 06796

(860) 672-6098 • Fax (860) 672-3489

www.michaeltrapp.com

July 24, 2024

514 Wells Hill Road Special Permit: Apartment above Garage

The Goal is to build a heated 4 car garage downstairs with a small guest apartment above. The garage will be made to park the cars 2 x 2 and a closed staircase off to the side will take you to the guest apartment. The apartment will have a full bath, studio kitchen and an area for sleeping. Clapboard exterior with asphalt shingle roof, double hung windows with mullions all painted a quiet green and landscaped.


TOWN OF SALISBURY, CONNECTICUT

Tue Jul 23 2024 11:35:29 GMT-0400 (Eastern Daylight Time)


Parcel ID	Site Address	Owner Name	Mailing Address	Mailing City	Mailing State	Mailing Zip
07-17-2	WELLS HILL ROAD	GREENBERG JEFFREY W & KIMBERLY E	950 PARK AVENUE APT 11B	NEW YORK	NY	10028- 0000
30-04	514 WELLS HILL ROAD	MCCORD ALAN & PRISCILLA	510 WELLS HILL ROAD	LAKEVILLE	СТ	06039- 0000
07-18	510+512 WELLS HILL ROAD	MCCORD ALAN H & PRISCILLA	510 WELLS HILL ROAD	LAKEVILLE	ст	06039- 0000
03-15-7	505 WELLS HILL ROAD	RIPPE RICHARD SURV & SANDRA SURV	22 EAST 88TH AT APT 12E	NEW YORK	NY	10128- 0000
30-05	530 WELLS HILL ROAD	WERTHEIMER ELLEN SURV &	200 N WYNNEWOOD AVE B407	WYNNEWOOD	PA	19096- 0000


Alyssa Fournier

From: Sent: Fo: Subjec Attach	t: ments:	bcolby@optonline.net Friday, July 19, 2024 11:51 AM Alyssa Fournier Fwd: 514 Wells Hill Rd 514 Wells Hill Rd.pdf	
Alyssa:			
Here is	preliminary approval to fill	for septic at 514 Wells Hill. Any questions feel free to call.	
3ill			
	Original Message From: CWeber@tahd To: bcolby@optonline Sent: Friday, July 19th Subject: 514 Wells Hi	.org e.net a 2024, 10:06	
	Hi Bill,		
	Rd. We still need add discussed. I have atta additional test holes of	ariance came through from the State Health Dept. for 514 Wells Hill ditional probes or test holes down gradient from the leach field, as ached the approval to fill sheet with the contingency needing or probes. I will complete the rest of the paperwork when I return 30 but wanted to update you on the progress.	
	Thanks,		
	Cathy		
	Catherine F. Weber, F	R.S.	
	Torrington Area Healt	h District	
	350 Main St., Suite A		
	Torrington, CT 06790		

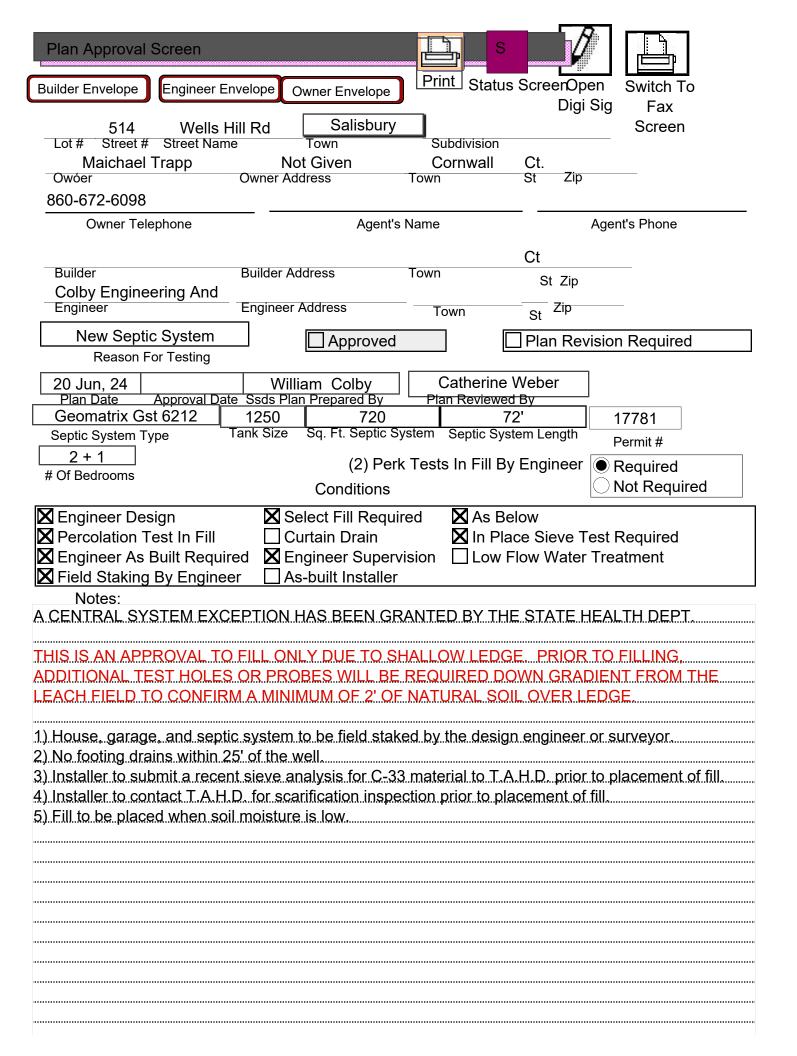

Michael Trapp, Inc.

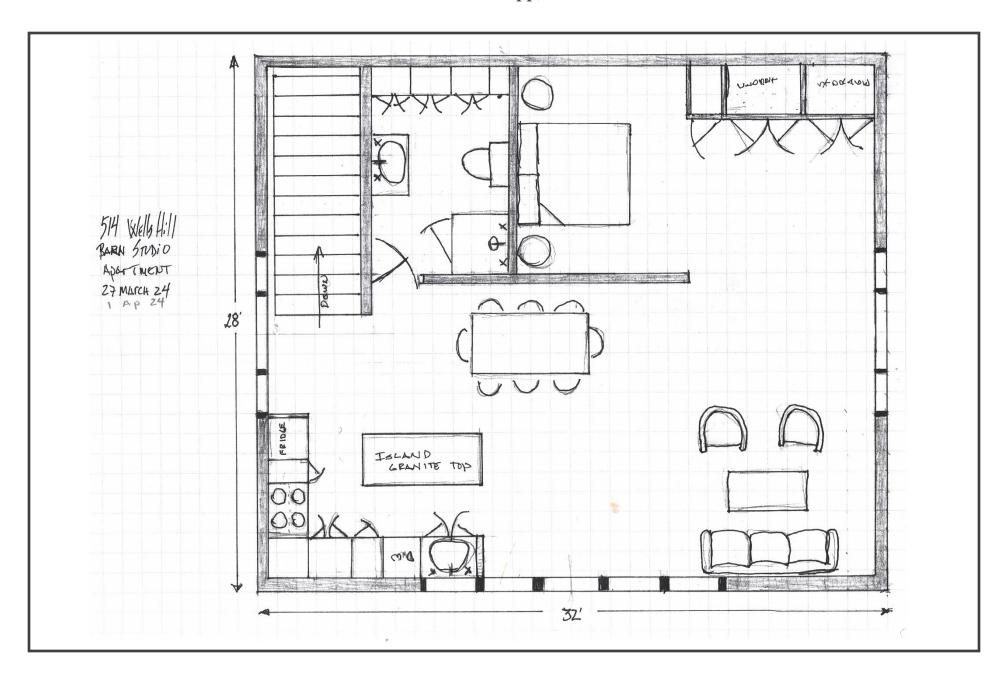

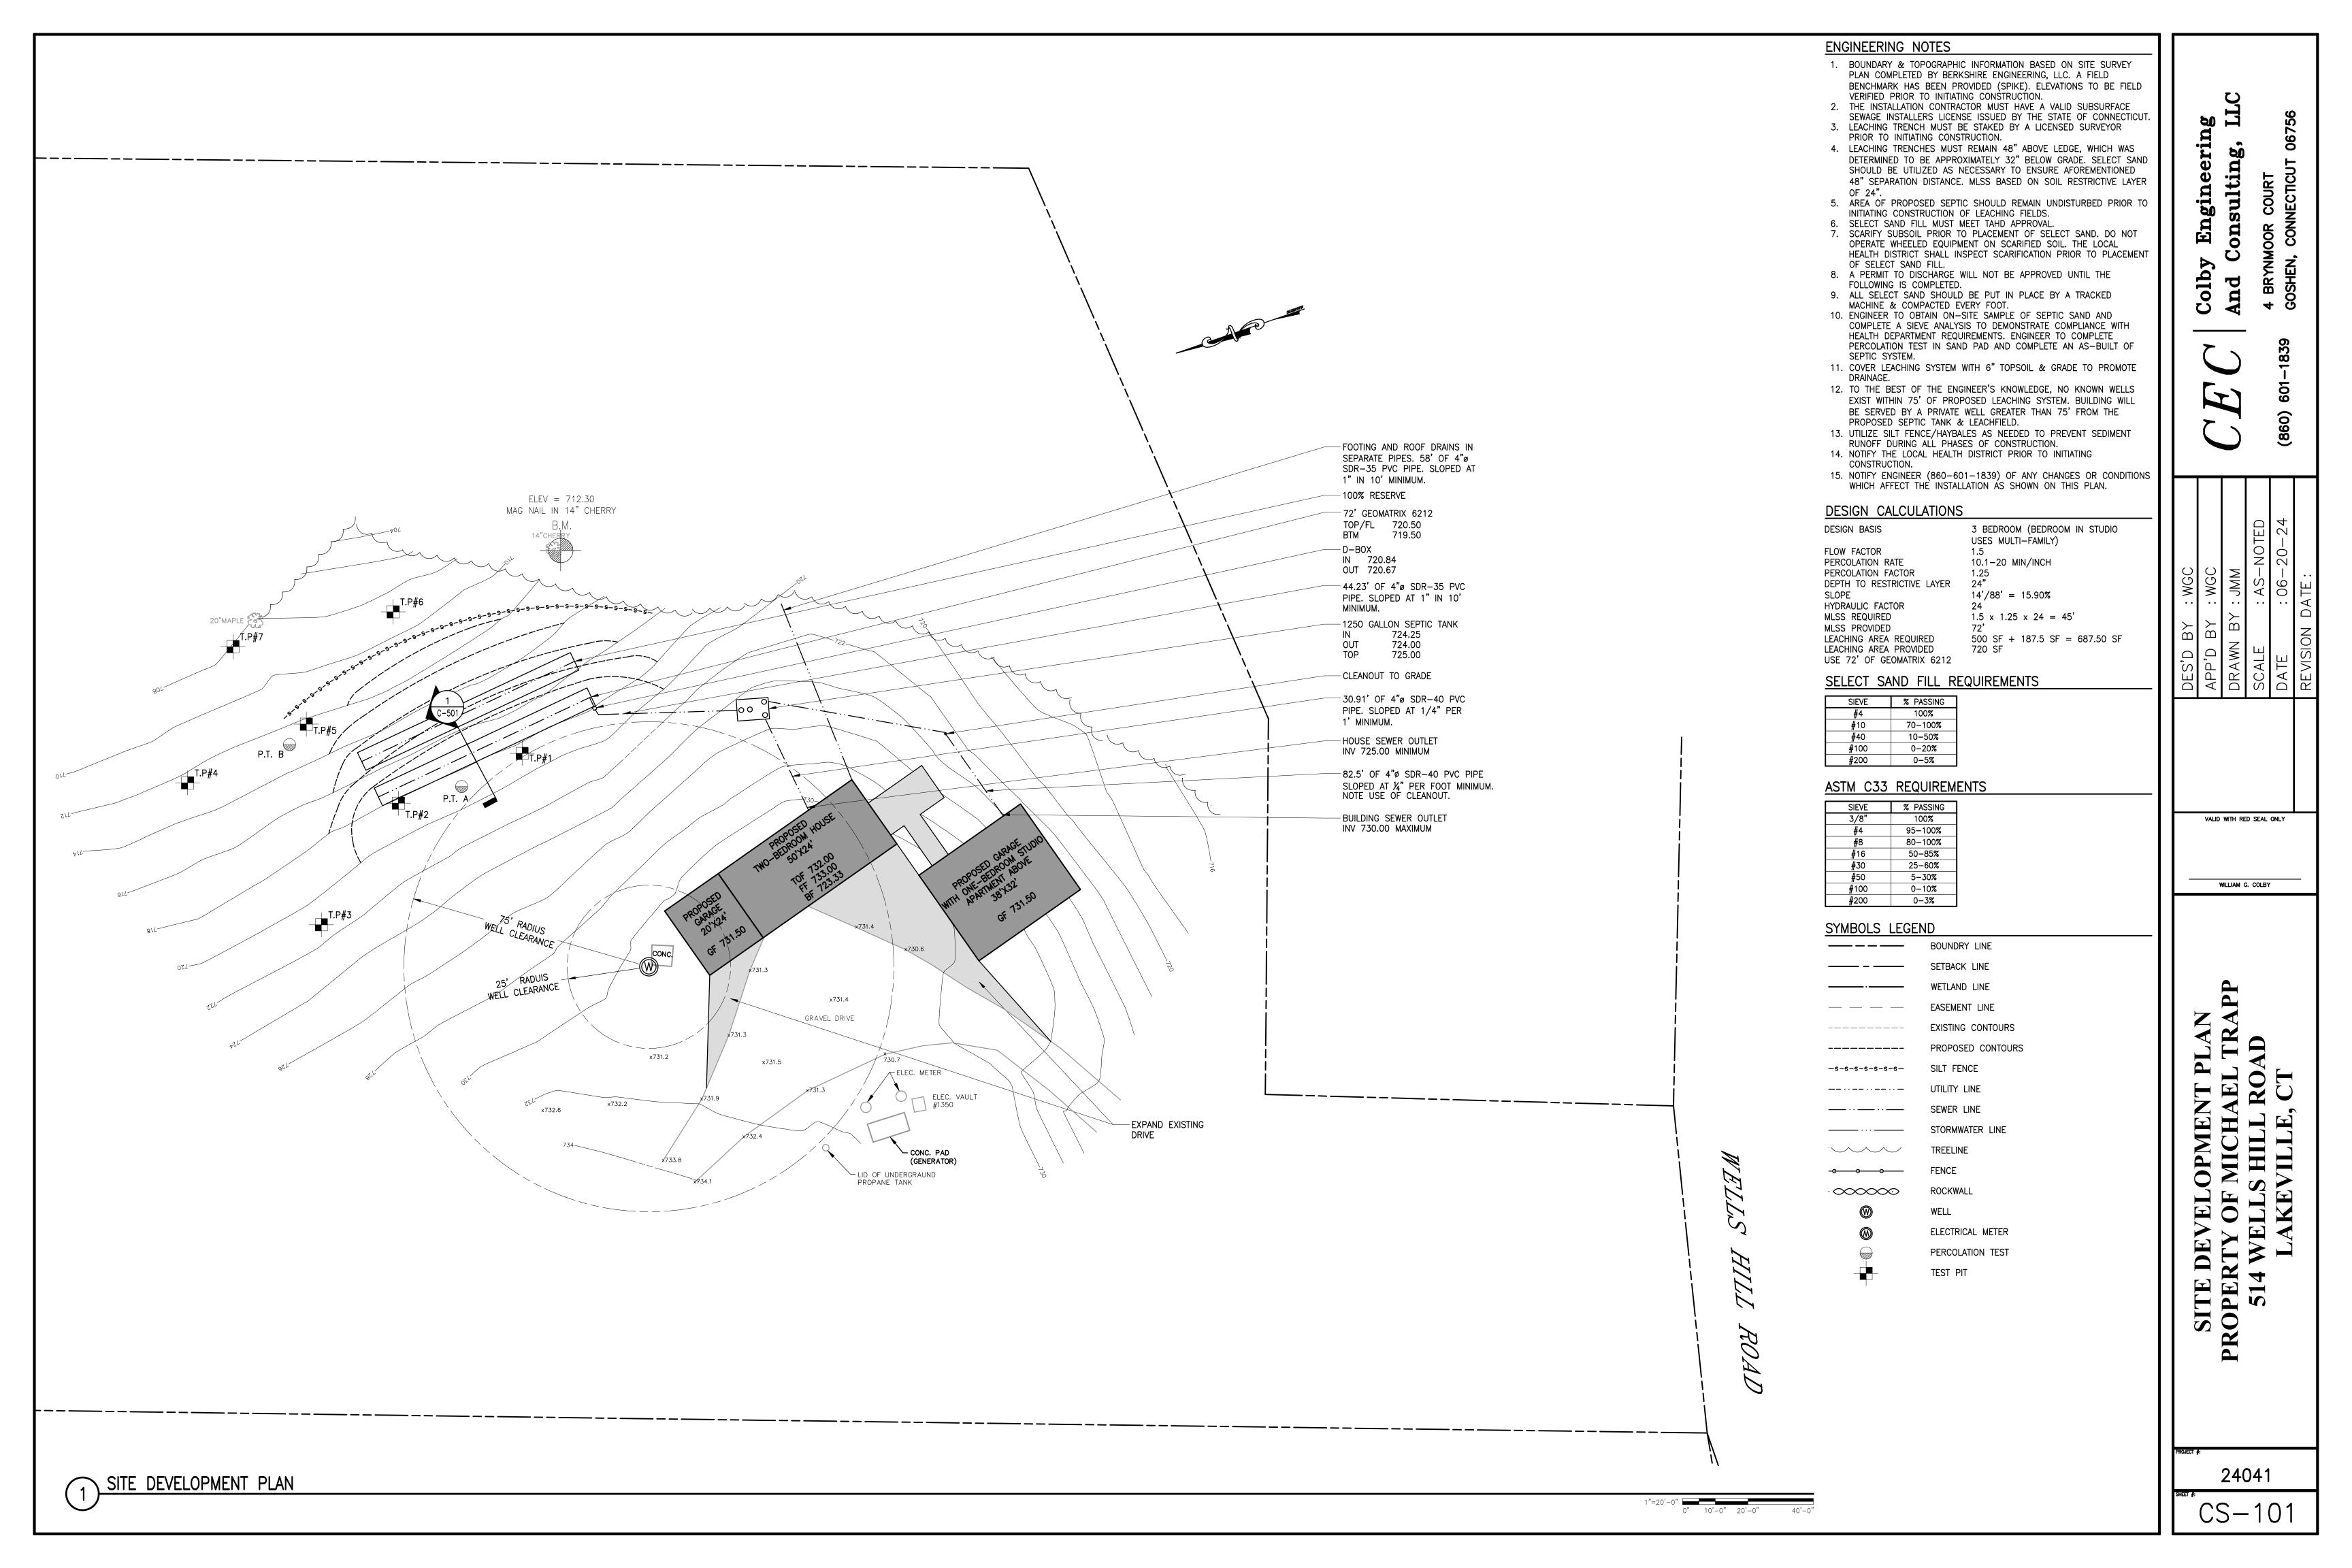




38'x32' LENOX CARRIAGE BARN FOR:

PRISCILLA & ALAN MCCORD

510 WELLS HILL RD LAKEVILLE, CT 06039

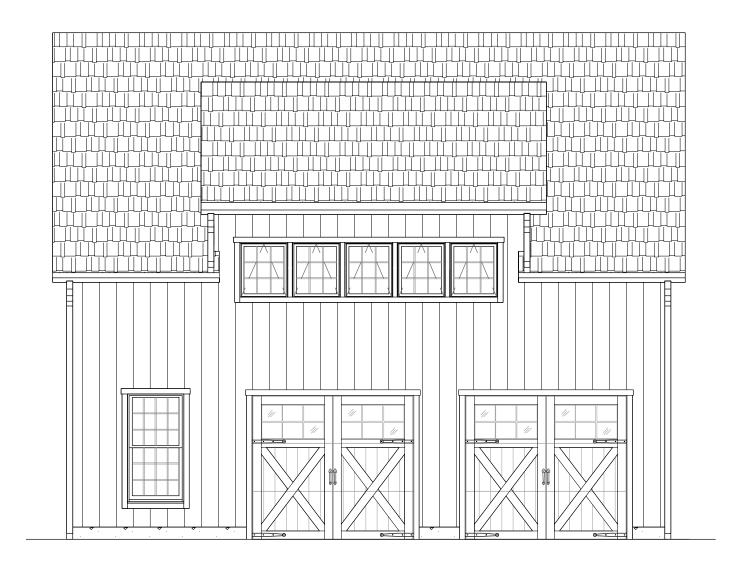

28' x 32' POST & BEAM CARRIAGE BARN W/ 10' ENCLOSED LEAN-TO

REVISION DATE: 02/21/2024 REVISION #:1



DRAWING LIST

TITLE SHEET & DESIGN DATA COYER ELEVATIONS ELEVATIONS SHEET 2 SHEET 3 FOUNDATION PLAN SHEET 4 POST & SILL PLAN FRAMING PLANS SHEET 6 FRAMING SECTIONS FRAMING SECTIONS SHEET 8 SHEET T NOTES & DETAILS

THE BARN YARD

MANUFACTURING & DESIGN FACILITY
9 VILLAGE ST.
ELLINGTON, CT 06029
860.454.9103

SHOWCASE LOCATIONS

120 WEST RD. RTE. 6
ELLINGTON, CT 06029 BETHEL, CT 06801

LINGTON, CT 06029 BETHEL, CT 06801 860.896.0636 203.740.7433

www.barnyard.com

CT LICENSE # 558916 MA LICENSE # 127550

THE BARN YARD CONTACT INFO:

PROJECT MANAGER
DRAKE SMITH
0: 860-454-9103 x152
C: 860-724-6802
DRAKE®BARNYARD.COM


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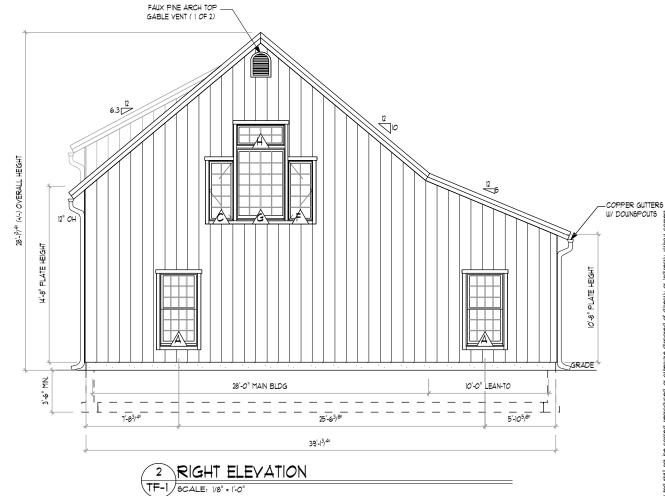
ELEVATIONS & RENDERINGS ARE ARTISTS CONCEPTIONS, COLOR AND OPTION STYLES MAY DIFFER FROM ACTUAL CONSTRUCTION,

PROJECT NO. 10051

M. SICONAL ENGINEERS

PRINT DATE: 03.12.2024



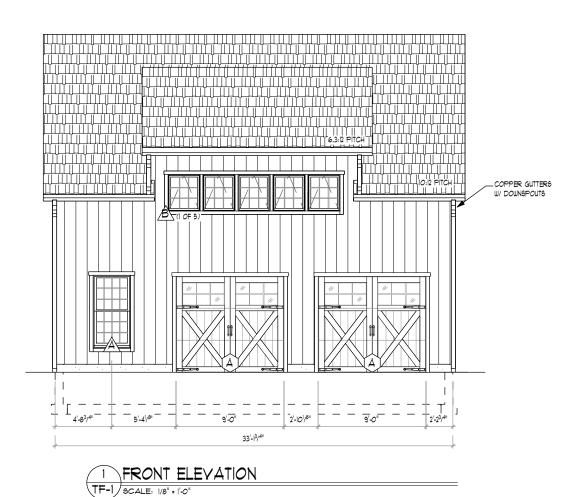

	WINDOW SCHEDULE						
	PROVIDED BY TBY						
LETTER	QTY.	MANUF.	MODEL	COLOR	EGRESS	TEMP.	R.O. (WxH)
A	4	ANDERSEN 400	TW30510	TBD	YES	NO	3'-2"x6'-0 7/8"
À	5	ANDERSEN 400	AXW281	TBD	NO	NO	2'-8"×3'-0 1/2"
Ê	1	ANDERSEN 400	CI5 CASMENT: OPEN LEFT	TBD	NO	NO	2'-0 5/8x5'-0 3/8"
À	1	ANDERSEN 400	CI5 CASMENT: OPEN LEFT	TBD	NO	YE6	2'-O 5/8x5'-O 3/8"
Æ	1	ANDERSEN 400	CI5 CASMENT: OPEN RIGHT	TBD	NO	NO	2'-0 5/8×5'-0 3/8"
Æ	1	ANDERSEN 400	CI5 CASMENT: OPEN RIGHT	TBD	NO	YE6	2'-0 5/8x5'-0 3/8"
Ġ	2	ANDERSEN 400	P4060	TBD	NO	YES	4'-0 1/2"x6'-0 3/8"
A	2	ANDERSEN 400	AN41 CASMENT: STATIONARY	TBD	NO	NO.	4'-0 1/2"×1'-9"

DOOR SCHEDULE						
PROVIDED BY TBY						
LETTER	QTY,	MODEL	COLOR	HINGE	SWING	R.O. (WxH)
A	2	9'XB' BELMONT SPANISH CEDAR OHD W/ 6 LITE GLASS 4 AUTHENTIC STRAP HINGES W/ LIFTMASTER MODEL 8500W MYQ JACKSHAFT WALL MOUNTED OPENER W/ KEYPAD	N/A	POWDER COATED TRACKS	N/A	9'-1"×8'-1"
B	1	Andersen A-Series model 179 entry door	PRIMED	LH	IN	3'-3×6'-10 1/2"



MANUFACTURING & DESIGN FACILITY
9 VILLAGE ST.
ELLINGTON, CT 06029
860.454,9103

86U-494-3103

SHOWLASE LOCATIONS

IZO WEST RD. RTE. 6

ELINATON, CT 06039 BETHEL, CT 06001

860-296-0636 203-140-1433

CT LICENSE 958016

MA LICENSE 9 121550

BULDING CODE: 2022 CONNECTICUT STATE BUILDING CODE. 2021 INTERNATIONAL RESIDENTIAL CODE. DESIGN NOTES:

DEAD LOADS: SECOND FLOOR: 15 PSF ROOF: 15 PSF

LIVE LOADS: SECOND FLOOR: 40 PSF ROOF: 20 PSF

SNOW LOADS: ROOF: GROUND = 40 PSF WIND LOADS: BASIC WIND SPEED(V): 115 MPH (3 SEC. GUST)

TIMBER NOTES:

HEMLOCK SPECIES: *2 OR BETTER P GRADE:

545 1/2" UNDER ROUGH DIM. (8X8 = 1.5"X1.5") BURFACE: BIZING: CHAMFERS: (NONE) (NONE)

FASTENER NOTES:

BOLTS, NUTS, WASHERS: DIA. AS NOTED, GALVANIZED, GRADE A301 TIMBER FRAME: - TRADITIONAL MORTISE & TENON JOINERY W/ 1" DIA, OAK PEGS AT

BEAM CONNECTIONS.

- TRADITIONAL WOOD CONNECTIONS TO BE SUPPLEMENTED BY

STRUCTURAL WOOD SCREWS AS NOTED,




PRISCILLA & ALAN MCCORD 510 WELLS HILL RD LAKEVILLE, CT 06039


DRAWING TITLE:

10051

ELEVATIONS

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EWS PROJECT ID:	
8 10051	

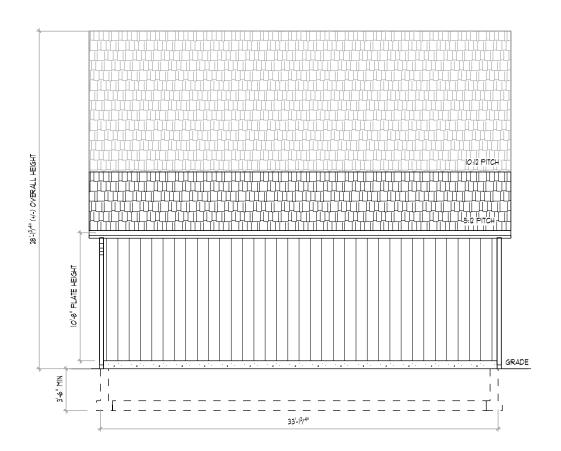

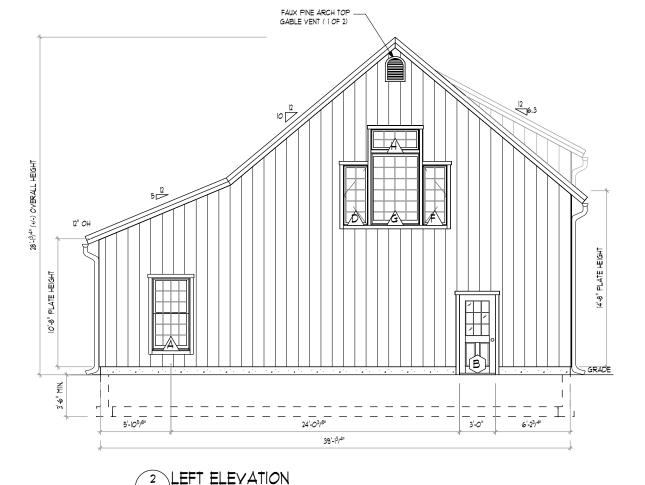

TF-2 SCALE: 1/8" = 1'-0"

REAR ELEVATION

TF-2 SCALE: 1/8" = 1'-0"

	BUILDING MATERIAL SCHEDULE	•
ITEM	DESCRIPTION	FINISH/COLOR
ROOF ASSEMBLY		•
ROOF DECKING	IX8 KILN DRIED PINE T&G DECKING	N/A
WEATHER BARRIER	SYNTHETIC UNDERLAYMENT	N/A
ROOF INSULATION	8.25" EPS SIP PANEL R-29	N/A
WEATHER BARRIER	SYNTHETIC UNDERLAYMENT	N/A
CEDAR BREATHER	CEDAR BREATHER	N/A
ROOFING	WESTERN RED CEDAR SHAKE ROOF SHINGLES	TBD
EAVE OVERHANGS	IX KILN DRIED PINE SHIPLAP	NONE
FASCIAS	IX PINE W/ IX3 PINE SHADOW BOARD	NONE
GABLE OVERHANGS	12" SIP OVERHANG	NONE
RAKES	IX PINE W/ IX3 PINE SHADOW BOARD	NONE
EXTERIOR WALL ASSEMBLY	1	
INTERIOR FINISH	5/8 SHEETROCK, SUPPLIED & INSTALLED BY CUSTOMER	N/A
SERVICE CAVITY	2X4 SERVICE CAVITY SPACED @24"O.C. (BY OTHERS)	
WALL INSULATION	4.5" EPS SIP PANEL R-15	N/A
WEATHER BARRIER	*15 FELT PAPER	N/A
NAILING BARRIER	IX3 HORIZONTAL FURRING STRIPS @ 24" O.C.	N/A
EXTERIOR SIDING	IXIO VERTICAL PINE SHIPLAP SIDING	NONE
EXTERIOR TRIM	IX4 PINE	NONE



THE BARN YARD

MANUFACTURING 4 DESIGN FACILITY
9 VILLAGE ST.
ELLINGTON, CT 06029
860,454,9103

86U-494-3103

SHOWLASE LOCATIONS

IZO WEST RD. RTE. 6

ELINATON, CT 06039 BETHEL, CT 06001

860-296-0636 203-140-1433

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DEAD LOADS:

LIVE LOADS: SECOND FLOOR: 40 PSF

ROOF: 20 PSF SNOW LOADS: ROOF: GROUND = 40 PSF

WIND LOADS: BASIC WIND SPEED(V): 115 MPH (3 SEC. GUST)

SECOND FLOOR: 15 PSF ROOF: 15 PSF

TIMBER NOTES:

HEMLOCK 6PECIES: *2 OR BETTER P GRADE:

SURFACE: 545 1/2" UNDER ROUGH DIM. (8X8 = 1.5"X1.5")

CHAMFERS: (NONE) (NONE)

FASTENER NOTES:

BOLTS, NUTS, WASHERS: DIA. AS NOTED, GALVANIZED, GRADE A301

TIMBER FRAME:
- TRADITIONAL MORTISE & TENON JOINERY W/ 1" DIA, OAK PEGS AT

BEAM CONNECTIONS, TRADITIONAL WOOD CONNECTIONS TO BE SUPPLEMENTED BY

STRUCTURAL WOOD SCREWS AS NOTED,

NO: DATE: REVISIONS / SUBMISSIONS




PRISCILLA & ALAN MCCORD 510 WELLS HILL RD LAKEVILLE, CT 06039


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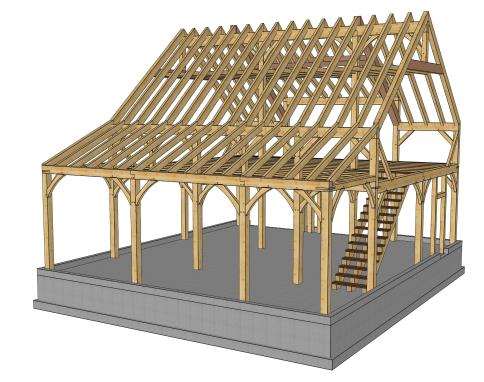
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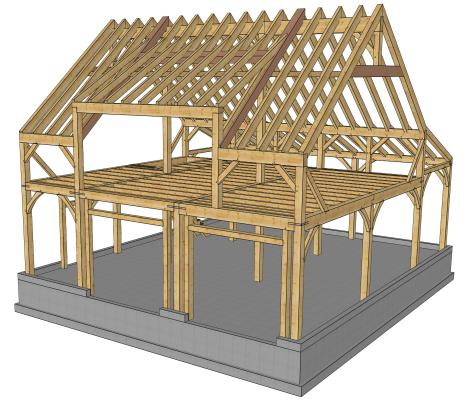
NOTE: 2X4 SERVICE CAVITY & SHEETROCK IS SUPPLIED & INSTALLED BY OTHERS





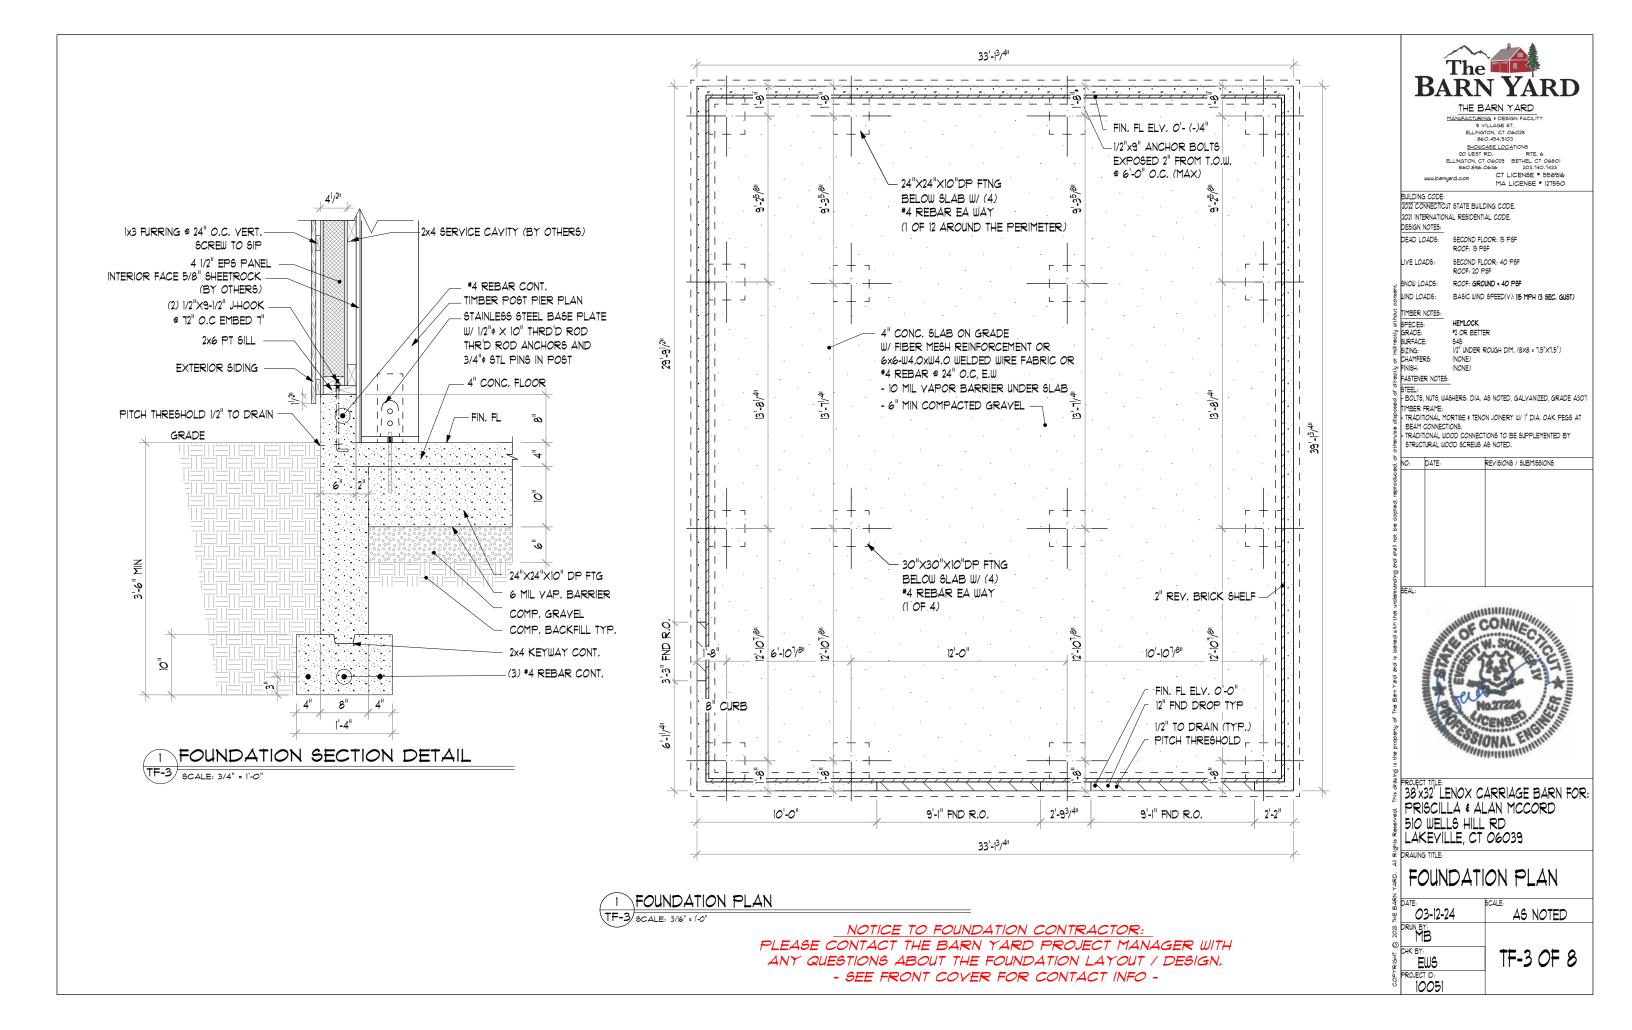



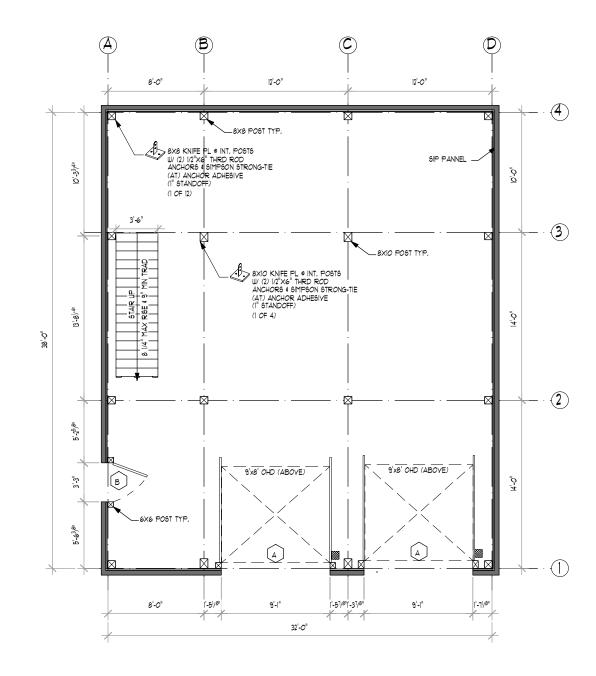

FRONT 3D RENDERING TF-4 SCALE: NTS



MANUFACTURING 4 DESIGN FACILITY
9 VILLAGE ST.
ELLINGTON, CT 06029
860,454,9103

86U-494-3103

SHOWLASE LOCATIONS

IZO WEST RD. RTE. 6

ELINATON, CT 06039 BETHEL, CT 06001

860-296-0636 203-140-1433

CT LICENSE 958016

MA LICENSE 9 121550

BUILDING CODE: 2022 CONNECTICUT STATE BUILDING CODE. 2021 INTERNATIONAL RESIDENTIAL CODE. DESIGN NOTES:

DEAD LOADS: SECOND FLOOR: 15 PSF ROOF: 15 PSF

LIYE LOADS: SECOND FLOOR: 40 PSF ROOF: 20 PSF

SNOW LOADS: ROOF: GROUND = 40 PSF

WIND LOADS: BASIC WIND SPEED(V): 115 MPH (3 SEC. GUST)

TIMBER NOTES:

6PECIES:
GRADE:
6URFACE:
6UZING:
CHAMFER6:
FINISH: HEMLOCK *2 OR BETTER

646 1/2" UNDER ROUGH DIM. (6X8 = 1.5"X1.5")

FASTENER NOTES:

TEEL:
BOLTS, NUTS, WASHERS: DIA, AS NOTED, GALYANIZED, GRADE A301

TIMBER FRAME:

TRADITIONAL MORTISE & TENON JOINERY W/ I" DIA, OAK PEGS AT

BEAM CONNECTIONS.

TRADITIONAL WOOD CONNECTIONS TO BE SUPPLEMENTED BY STRUCTURAL WOOD SCREWS AS NOTED.

REVISIONS / SUBMISSIONS




BROJECT TITLE:
38 x32 LENOX CARRIAGE BARN FOR:
PRISCILLA & ALAN MCCORD 510 WELLS HILL RD LAKEVILLE, CT 06039


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POST & SILL PLAN

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NOTE: 2X4 SERVICE CAVITY & SHEETROCK IS SUPPLIED & INSTALLED BY OTHERS



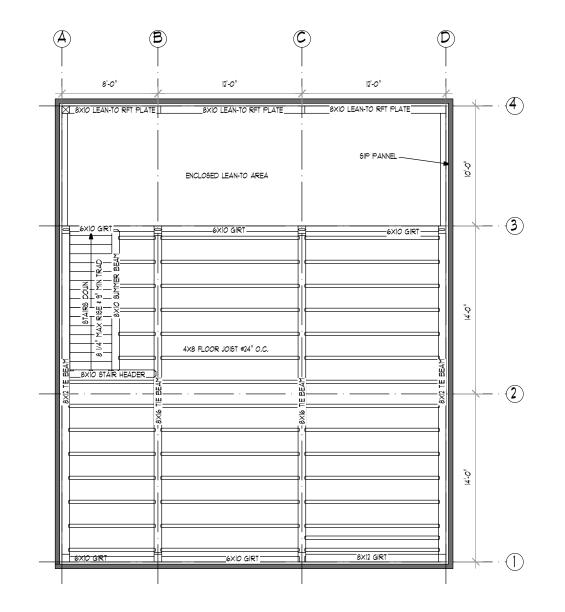

1 SECOND FLOOR FRAMING PLAN

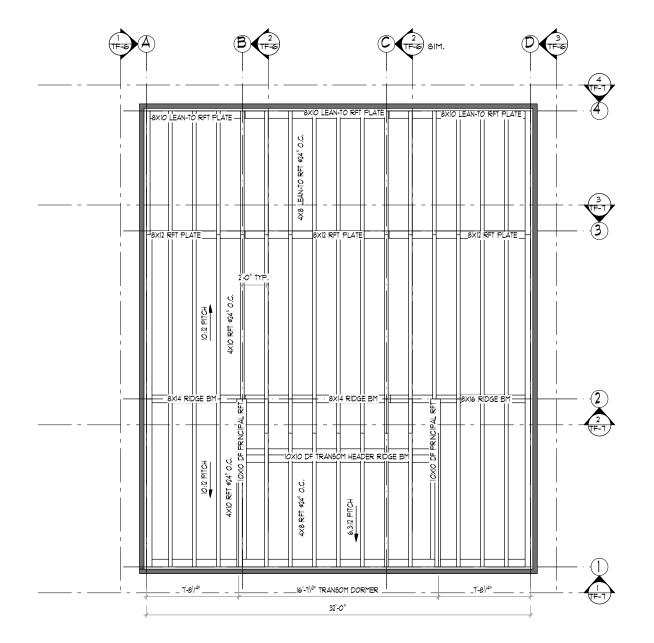TF-5 SCALE: 1/8" = 1'-0"

2 ROOF FRAMING PLAN TF-5 SCALE: 1/8" = 1'-0"

THE BARN YARD

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86U-494-3103

SHOWLASE LOCATIONS

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ELINATON, CT 06039 BETHEL, CT 06001

860-296-0636 203-140-1433

CT LICENSE 958016

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SNOW LOADS: ROOF: GROUND = 40 PSF WIND LOADS: BASIC WIND SPEED(V): II5 MPH (3 SEC. GUST)

SECOND FLOOR: 15 PSF ROOF: 15 PSF

TIMBER NOTES:

HEMLOCK *2 OR BETTER

PECIES:

PECIES:

GRADE:

BURFACE:

BIZING:

CHAMFERS:

TINISH:

FASTENER NOTES: 545 1/2" UNDER ROUGH DIM. (8X8 = 1.5"X1.5")

TEEL:
BOLTS, NUTS, WASHERS: DIA, AS NOTED, GALYANIZED, GRADE A301 TIMBER FRAME:
TRADITIONAL MORTIGE & TENON JOINERY W/ I" DIA, OAK PEGS AT

BEAM CONNECTIONS,

- TRADITIONAL WOOD CONNECTIONS TO BE SUPPLEMENTED BY

STRUCTURAL WOOD SCREWS AS NOTED.

REVISIONS / SUBMISSIONS





ROJECT TITLE:
38 X32 LENOX CARRIAGE BARN FOR:
PRISCILLA & ALAN MCCORD 510 WELLS HILL RD LAKEVILLE, CT 06039

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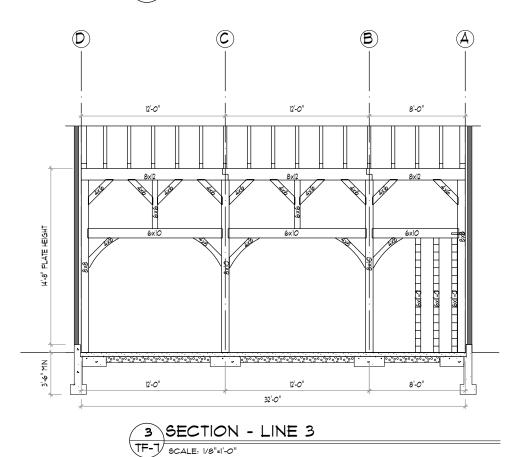
FRAMING PLANS


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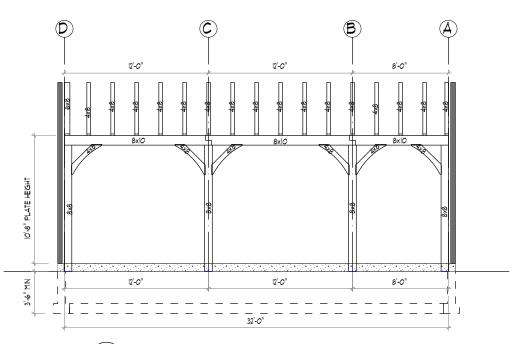




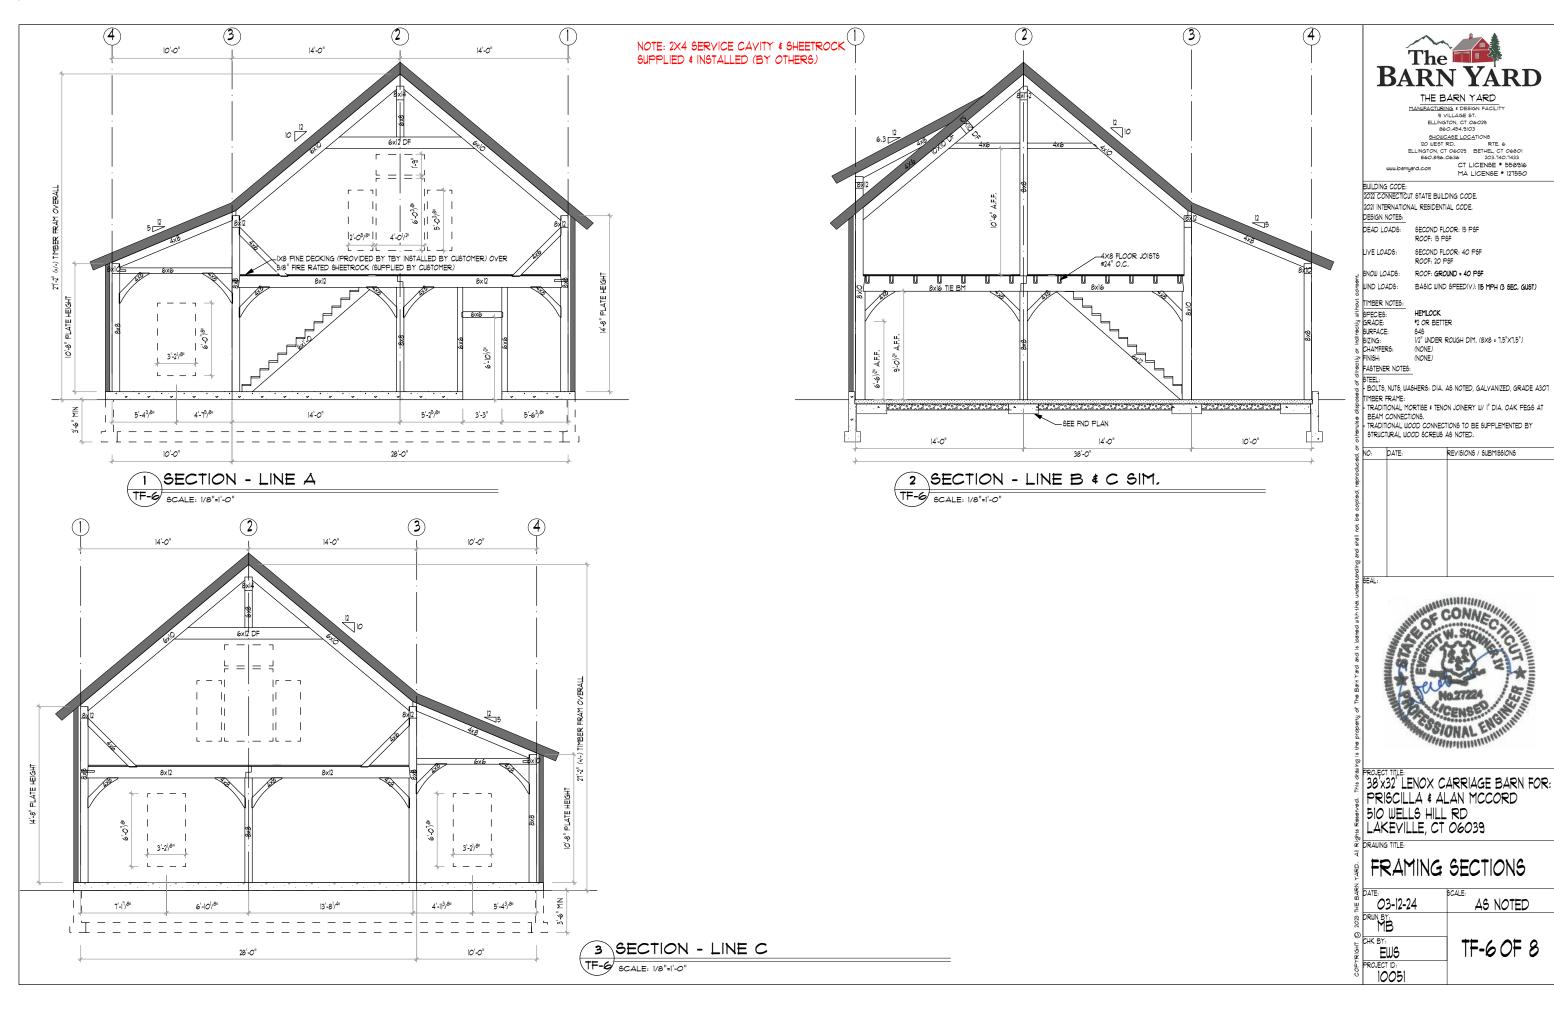

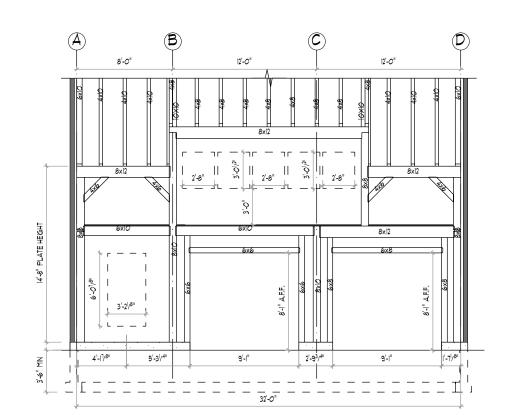



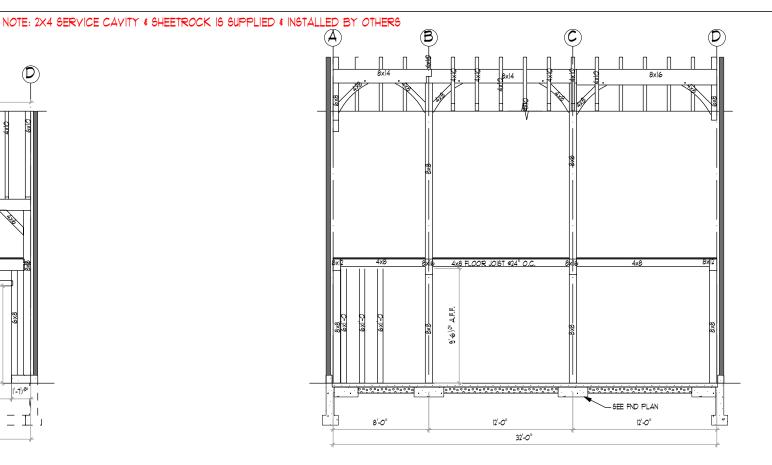

4 SECTION - LINE 4 TF-7 SCALE: 1/8"=1'-0"

The BARN YARD

THE BARN YARD

MANUFACTURING & DESIGN FACILITY 9 VILLAGE 9T. ELLINGTON, CT 06029 860.454.9103

86U-494-3103

SHOWLASE LOCATIONS

IZO WEST RD. RTE. 6

ELINATON, CT 06039 BETHEL, CT 06001

860-296-0636 203-140-1433

CT LICENSE 958016

MA LICENSE 9 121550

BUILDING CODE: 2022 CONNECTICUT STATE BUILDING CODE. 2021 INTERNATIONAL RESIDENTIAL CODE. DESIGN NOTES:

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SECOND FLOOR: 15 PSF ROOF: 15 PSF LIYE LOADS:

SECOND FLOOR: 40 PSF ROOF: 20 PSF

SNOW LOADS: ROOF: GROUND = 40 PSF

WIND LOADS: BASIC WIND SPEED(V): 115 MPH (3 SEC. GUST)

TIMBER NOTES:

HEMLOCK *2 OR BETTER

OPECIES:
GRADE:
GRADE: 646 1/2" UNDER ROUGH DIM, (8X8 = 1.5"X1.5")

FASTENER NOTES:

TEEL:
BOLTS, NUTS, WASHERS: DIA, AS NOTED, GALVANIZED, GRADE A301

TIMBER FRAME: TRADITIONAL MORTISE & TENON JOINERY W/ 1" DIA, OAK PEGS AT

BEAM CONNECTIONS.

- TRADITIONAL WOOD CONNECTIONS TO BE SUPPLEMENTED BY STRUCTURAL WOOD SCREWS AS NOTED.

REVISIONS / SUBMISSIONS



ROJECT TILLE 38 x32 LENOX CARRIAGE BARN FOR: PRISCILLA & ALAN MCCORD 510 WELLS HILL RD LAKEVILLE, CT 06039

DRAWING TITLE:

FRAMING SECTIONS

ă рате: 23-12-24	AS NOTED
DRUN BY:	
CHK BY: EWS PROJECT ID:	TF-7 OF 8
PROJECT ID:	

STRUCTURAL NOTES

ALL WORK SHALL CONFORM TO THE CURRENT REQUIREMENTS OF 2022 CONNECTICUT STATE BUILDING CODE & 2021 INTERNATIONAL RESIDENTIAL BUILDING CODE, DIMENSIONS AND DETAILS SHALL BE CHECKED AGAINST ENGINEERING DRAWINGS. THE CONTRACTORSHALL YERIFY AND COORDINATE THE SIZE AND LOCATION OF ALL OPENINGS, SLEEVES AND ANCHOR BOLTS AS REQUIRED BY ALL TRADES OPENINGS NOT SPECIFICALLY SHOWN SHALL BE APPROVED BY THE ENGINEER ALL WORK TO CONFORM TO ALL APPLICABLE LOCAL STATE AND NATIONAL

CODES AND REGULATIONS, AND THE OWNERS OR DESIGNATED CONTRACTORS SHALL SECURE APPROPRIATE PERMITS REQUIRED BEFORE COMMENCEMENT OF ACTUAL CONSTRUCTION. ALL CONTRACTORS SUBCONTRACTORS SUPPLIERS AND ALL OTHER PERSONS ENGAGED IN ANY CAPACITY ON THIS PROJECT SHALL BE SUBJECT TO PROVISIONS OF THE OSHA (OCCUPATIONAL SAFETY AND HEALTH ADMINISTRATION) WHICH IS ADMINISTERED AND ENFORCED BY U.S. DEPARTMENT OF HEALTH,

FOUNDATIONS:

ALL FOOTINGS SHALL BEAR ON UNDISTURBED NATURAL MATERIAL OR GRANULAR FILL. ELEVATIONS OF BOTTOM OF FOOTING SHOWN ON PLANS ARE FOR BIDDING PURPOSES AND SHALL BE LOWERED IF NECESSARY TO THE REQUIRED BEARING MATERIAL AS FOUND UPON EXCAVATION IF THE REQUIRED BEARING MATERIAL IS NOT ENCOUNTERED AT ELEVATIONS SHOWN, NOTIFY ENGINEER IMMEDIATELY, CONTROLLED BACK FILL AND COMPACTION IF REQUIRED.

- A. SCOPE: WHERE UNACCEPTABLE, MATERIAL MUST BE REMOVED AND REPLACED WITH PROPER MATERIAL A CONTROLLED PROCEDURE MUST BE FOLLOWED TO ENSURE PROPER BEARING FOR THE BUILDING.
- B. FILLING AND GRADING: BEFORE BACK FILLING, REMOVE CONSTRUCTION DEBRIS, STUMPS, TREES, ROOTS, SOD, HEAVY GRASS DECAYED VEGETABLE MATTER AND OTHER UNSUITABLE MATERIALS, FILL MATERIAL SHALL BE AS APPROVED BY THE ENGINEER.
- C. CONSTRUCTION METHODS: AFTER DEPOSITING FILL OR BACK FILL IN 1 FOOT LIFTS, WELL WASHED IN COMPACT TO THE FOLLOWING PERCENT OPTIMUM


THE DRY DENSITY AFTER COMPACTION SHALL NOT BE LESS THAN 95% OF THE DRY DENSITY FOR THAT SOIL WHEN TESTED IN ACCORDANCE WITH ASTM DISST, METHOD D. IN THIS


TEST, MATERIALS RETAINED ON THE THREE-QUARTER SIEVE SHALL BE REPLACED WITH MATERIAL RETAINED ON THE NO. 4 SIEVE, AS NOTED AS AN OPTION IN THE SPECIFICATIONS FOR THIS TEST.

D. FIELD TESTS: PERFORM ONE FIELD DENSITY TEST FOR EACH SOURCE OF FILL MATERIAL PERFORMED IN ACCORDANCE WITH ASTM DISSO. PERFORM STANDARD FIELD DENSITY TESTS EACH OF AN ACCURACY OF PLUS OR MINUS ONE PERCENT, IT SHALL BE THE CONTRACTORS RESPONSIBILITY TO NOTIFY THE ENGINEER AND TESTING LABORATORY WHEN EACH LAYER OF FILL IS TO BE PLACE AND READY FOR TESTING THE CONTRACTOR SHALL ALLOW AMPLE TIME FOR TESTING, IF ANY FILL IS PLACED IN EXCESS OF SIXTEEN (16) WITHOUT TESTING, IT SHALL BE SUBJECT TO REMOVAL, SIEVE ANALYSIS SHALL BE AT THE CONTRACTOR'S EXPENSE.

E. OBSERVATION: ALL EXCAVATION OF UNACCEPTABLE MATERIAL, INSTALLATION OF CONTROLLED FILL, COMPACTION, FIELD TESTING AND LABORATORY TESTING SHALL BE DONE UNDER THE SUPERVISION OF A TESTING LABORATORY WHO SHALL PROVIDE WRITTEN REPORTS OF ALL PHASES OF THE WORK

TO THE ENGINEER

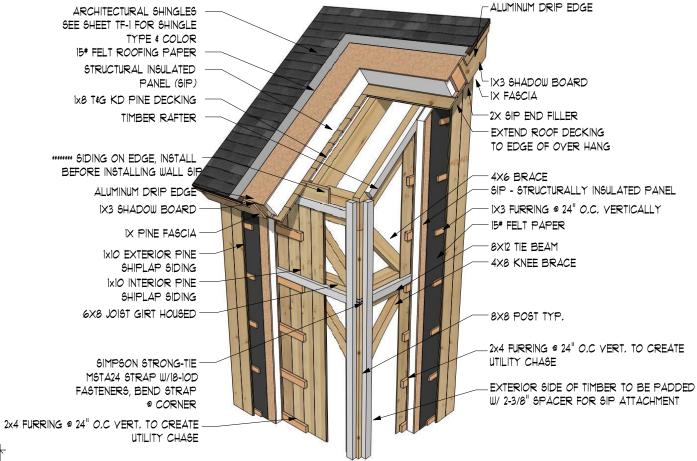

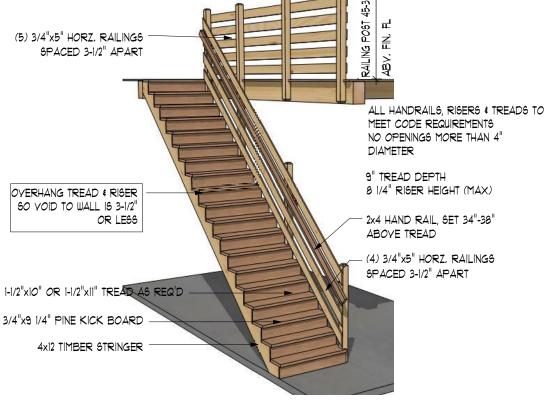

STAIR & HANDRAIL DETAIL

SCALE: N.T.S

FRAMING DETAIL W/SIP & UTILITY CHASE

SCALE: N.T.S

FRAMING DETAIL W/SIP & UTILITY CHASE

SCALE: NITS

THESE DETAILS ARE THE BARN YARD'S STANDARD RECOMMENDATION OF BEST PRACTICES FOR SIP PANEL BUILDINGS ONLY AND MAY NOT MATCH THE EXACT CONFIGURATION OF YOUR BUILDING PROJECT, PLEASE CONTACT YOUR PROJECT MANAGER FOR ALL QUESTIONS ABOUT HIGH PERFORMANCE BUILDINGS AND RECOMMENDED FINISHING DETAILS.





MANUFACTURING & DESIGN FACILI

9 VILLAGE 9T. ELLINGTON, CT 06029 860.454.9103 SHOWCASE LOCATIONS

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BUILDING CODE 2022 CONNECTICUT STATE BUILDING CODE. 2021 INTERNATIONAL RESIDENTIAL CODE. DESIGN NOTES:

DEAD LOADS: SECOND FLOOR: 15 PSF ROOF: 15 PSF

SECOND FLOOR: 40 PSF IVE LOADS: SNOW LOADS: ROOF: GROUND = 40 PSF

WIND LOADS: BASIC WIND SPEED(V): 115 MPH (3 SEC. GUST)

TIMBER NOTES:

HEMLOCK SPECIES: *2 OR BETTER " GRADE: BURFACE:

1/2" UNDER ROUGH DIM, (8X8 = 1,5"X1,5") SIZING: CHAMFERS:

FINISH: FASTENER NOTES:

BOLTS, NUTS, WASHERS: DIA, AS NOTED, GALVANIZED, GRADE A301 TIMBER FRAME:

- TRADITIONAL MORTISE & TENON JOINERY W/ I" DIA, OAK PEGS AT BEAM CONNECTIONS.

- TRADITIONAL WOOD CONNECTIONS TO BE SUPPLEMENTED BY

STRUCTURAL WOOD SCREWS AS NOTED.

REVISIONS / SUBMISSIONS



38 x 32 LENOX CARRIAGE BARN FOR: PRISCILLA & ALAN MCCORD 510 WELLS HILL RD LAKEVILLE, CT 06039

DRAWING TITLE:

NOTES & DETAILS

03-12-24 AS NOTED DRUN BY: TF-8 OF 8 EWS PROJECT